

Planning and Development 222 3<sup>rd</sup> Avenue North Saskatoon SK S7K 0J5 www.saskatoon.ca tel (306) 975-2645 fax (306) 975-7712

May 3, 2019

Mark Kindrachuk

Saskatoon SK

FOR EMPIRICATION
ONLY
VIA EMAIL

Dear Mr. Kindrachuk:

Re:

**Development Permit Denial** 

221 10th St E

**New One Unit Dwelling** 

R2: One and Two-Unit Residential District

MAY 0 3 2019
CITY CLERK'S OFFICE SASKATOON

The Planning and Development Division has reviewed your development permit application to construct a new one unit dwelling at 221 10th St E. This property is located in a R2 Zoning District and based on the information provided, the following deficiencies have been identified:

1) Requirement: Section 8.4.2(1) states that the minimum front yard setback for a One Unit Dwelling is 6 meters.

Proposed: The proposed one unit dwelling has a front yard setback of 5.182 meters.

<u>Deficiency</u>: The proposed one unit dwelling will create a front yard setback deficiency of 0.818 meters.

As consequence, the Community Services Department cannot approve your plans for a Development Permit.

In the event that you wish to appeal this decision, I have attached a Development Appeal brochure and application form as well an extract from *The Planning and Development Act 2007*, which outlines the procedures for an appeal. If you decide to appeal, please contact the Development Appeals Board Secretary, City Clerk's Office, City Hall at 306-975-3240 within 30 days of the date of this letter. Please note that the required fee for this process is \$50 payable to the City of Saskatoon.

If you have any questions pertaining to the above, please contact me.

Sincerely

Grace de Wit

**Development Officer** 

Planning and Development Division (306-986-3669)

cc: Paula Kotasek-Toth, Development Review
Development Appeal Board Secretary, City Clerks



PROJECT ADDRESS

# For Appears

222-3rd AVE NORTH, SASKATOON, SK S7K 0J5

**Appeal 14-2019** 

1

# BUILDING AND DEVELOPMENT PERMIT APPLICATION ALL PROJECTS

Address / 10th Street	Fast	Unit Number
Legal Description(optional) 25	4() 1/8) Block(s) Plar	Number \$
Lot(s) Has addressing been approved by Com		Value of Construction_
TYPE OF PROJECT		
Residential Only Complete & Submit Page 2	☐ Alternative Family Care Home Complete & Submit Page 2	☐ Commercial/Industrial/Institutional/Mixed Occupancy Residential Complete & Submit Page 3
☐ Demolition Complete & Submit Page 4	☐ Removal Off Site Complete & Submit Page 4	☐ Relocation On Site Complete & Submit Page 4
Do any of the following apply to thi	is project?   ☐ Encroachment*	☐ Occupancy*
Additional documents will be required.  CONTACT INFORMATION**	4	
//	Park Kindrachuh	
Applicant Address	siness Name: On The Mark 1	Residential Project Management Ltd Suglection Sk City Provi
Émail: Mail	rkeotmhomes, ca	Phone/Cell#:
Owner or Registered Bus	siness Name:	
	Unit Number 5 Street	City Province Postal Code  Phone/Cell#:
Name:	·	
Contractor Registered Bus	siness Name:	
permit can be issued)  Address.  Email:	Unit Number Street	City Province Postal Code  Phone/Cell#:
	oject, please complete and submit the Design Pro	
		· · · · · · · · · · · · · · · · · · ·
Canada, as amended and wit Bylaw. The applicant is the ov The submission of this applica shall not commence until the All building construction is to be Building Standards may canor required fee is not paid or info	hin the scope of the Uniform Building and A wner of the building or property or an author ation does not give permission to begin worl prescribed fee is paid in full and the building be completed on site unless a written reque- el and destroy the building permit application ormation required to continue processing the ation in accordance with The Local Authority	aplying with the requirements of the National Building Code of ccessibility Standards Act and the City of Saskatoon Building ized representative of the owner who applies for a building permit. It is project. Work under the scope of this permit application appropriate permit has been issued. It is approved by Building Standards.  In and supporting documents 180 days following permit review if the
I certify that I have read and duree	to abide by the conditions above, and	all information contained within this application is correct.
1 8 1 0		Mas 1/19
Applicant's Signature	Familiation). The abiliation (2)	Date // /
vieulod of Payment (If Known at time o	f application): ☐ Cash/Debit/Cheque/Cre Incomplete ap	pplications will not be accepted or will increase review time.

BBA Number: COL

BPA Number: (office use only)

#### **ZONING REVIEW**

BASED ON BYLAW #8770

ZONE: R2 DISTRICT: ONE UNIT DWELLING (OUD)

10.86m

**PROPOSED** 

-	SITE WIDTH	SITE DEPTH	SITE AREA	FRONT YARD	REAR YARD CORNER	BUILDING HEIGHT	SITE COVERAGE
REQUIRED	7.5m	30m	224m²	6m	4.5m	8.5m	44%

#### **ZONING REVIEW**

23.365m

8.5m

25%

BASED ON BYLAW #9249

- 1. Building wall height calculations: the wall height is determined by a 45 degree angular plane, measured from a height of 6 metres, projecting vertically from the side property line. The allowable wall height is determined where the building setback intersects the 45 degree angular plane;
- 2. For sites 40 metres or less in depth, the maximum is 14 metres; and

42.672m

3. Allowable sidewall area is calculated by multiplying building height and wall length.

463.4m<sup>2</sup>

5m

- 4. The bottom or sill of an entrance facing the front yard of a primary dwelling in category 1 neighbourhood shall not be located more than 1.0 metres above the finished grade.
- 5. A front porch on a primary dwelling in a category 1 neighbourhood shall be a maximum of 50% of the width of the front of the dwelling and may encroach up to 3.0 metres into a required front yard.

#### PROJECT INFORMATION:

#### CIVIC ADDRESS:

221 10th Street East SASKATOON, SASKATCHEWAN


#### LEGAL DESCRIPTION:

LOT 25 BLOCK 40 **PLAN B1858** 

#### AREAS:

#### 2241 ft<sup>2</sup> LIVING AREA

BASEMENT: 1269ft<sup>2</sup> (118m<sup>2</sup>) MAIN FLOOR: 1269ft<sup>2</sup> (118m<sup>2</sup>) SECOND FLOOR: 972ft<sup>2</sup> (94.4m<sup>2</sup>)

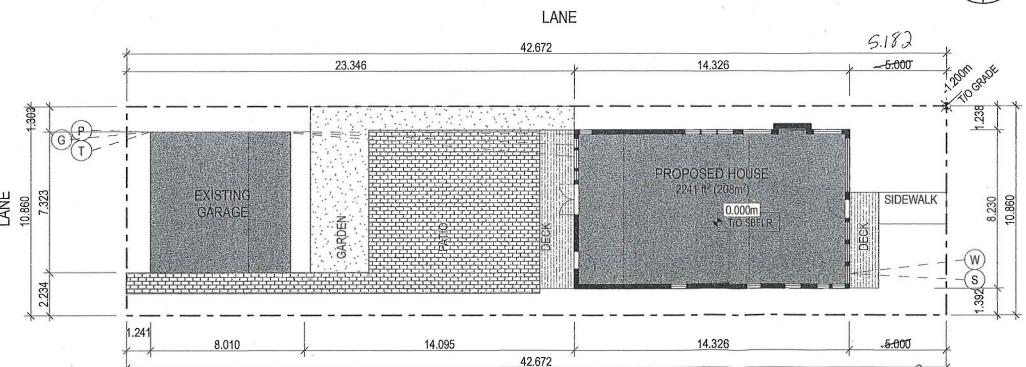

# SITE PLAN SCALE: 1/16" = 1'-0"

### NOTES:

- 1. IT IS THE RESPONSIBILITY OF THE CONTRACTOR TO ENSURE THAT THE PROPOSED STRUCTURE WILL NOT ENCROACH UPON ANY ELECTRICAL OR GAS LINES OR ANY EASEMENTS REGISTERED AGAINST THE PROPERTY IN QUESTION. THE LOCATION OF THE ELECTRICAL OR GAS LINES MAY BE LOCATED BY CONTACTING SASKPOWER OR SASKENERGY RESPECTIVELY.
- 2. SITE SECURITY MUST BE PROVIDED DURING NEW CONSTRUCTION IN ESTABLISHED AREAS AND AS REQUIRED BY THE BUILDING INSPECTOR. THE SITE SECURITY SHALL BE A 6FT CONSTRUCTION FENCE AND WILL BE REQUIRED UNTIL ALL OPENINGS UP TO 6FT FROM GRADE ARE SEALED.
- 3. THIS DRAWING IS NOT A LEGAL SURVEY AND IS INTENDED FOR PLANNING PURPOSES ONLY.
- . PROVIDE MINIMUM 5% SLOPE AWAY FROM THE FOUNDATION WALL TO 3M. PROVIDE 2% SLOPE BEYOND.
- 5. SAFEGUARD AND PROTECT ALL EXISTING TREES THAT MAY BE AFFECTED BY THIS WORK, IDENTIFY ALL CITY OWNED TREES AND PROTECT AS PER CITY OF SASKATOON TREES.
- S.SIDEWALLS CLOSER THAN 1.2m TO THE PROPERTY LINES REQUIRE 45min FIRE RATING. PROVIDE 5/8" TYPE X GYPSUM INSIDE FACE AND NON-COMBUSTIBLE EXTERIOR CLADDING.

EAST

10th ST

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#### ROBICHAUD/THOMSON RESIDENCE

221 10th STREET E BUILT BY: OTM HOMES

SHOP DRAWING APPROVAL DATE DESC.

REV DATE DESC.

DRAWN BY: CMB PROJECT NO: 1895

DATE: MAY 1, 2019 SCALE: AS SHOWN/11x17 LAYOUT ISSUED: CLIENT REVIEW

SITE PLAN



# PROPOSED RESIDENCE

FOR
BENJAMIN THOMSON &
MARTINE ROBICHAUD

221 10th Street East SASKATOON, SASKATCHEWAN

# **DRAWING LIST**

A0.0 **COVER SHEET** A0.1 **GENERAL INFORMATION** A0.2 **GENERAL INFORMATION** A0.3 **GENERAL INFORMATION** SITE PLAN A1.0 **FOUNDATION** A2.1 A2.2 1st FLOOR PLAN A2.3 2nd FLOOR PLAN A2.4 **ROOF PLAN** E2.1 **ELECTRICAL PLANS** A3.1 **ELEVATIONS** SECTION & ASSEMBLIES A4.1 A4.2 SECTION A6.1 INTERIOR ELEVATIONS **DETAILS** A9.1 A10.1 WINDOW & DOOR SCHEDULES

# CLIENT APPROVAL:

I HAVE REVIEWED THE ENCLOSED PAGES AND APPROVE OF THESE DRAWINGS:

NAME:
SIGNATURE:
DATE:

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# ROBICHAUD/THOMSON RESIDENCE

221 10th STREET E
BUILT BY: OTM HOMES

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DRAWN BY: CMB PROJECT NO: 1895 DATE: APRIL 18, 2019

SCALE: AS SHOWN/11x17 LAYOUT ISSUED: CLIENT REVIEW

MODEL FILE: 1895-CD01

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COVER SHEET

A0.0

#### GENERAL NOTES:

- A. All construction to comply with Building Code regulations, rules, and by-laws set by the authority having jurisdiction.
- B. Provide and maintain continuous air/vapour barrier system, caulk around openings and gaps with sealant to achieve a continuous barrier.
- C. Verify all conditions and dimensions on site prior to fabrication, promptly notify the designer of any errors or omissions.
- D. Dimensions are taken to outside edge of sheathing on exterior walls and foundation, and to centre of interior partition.
- E. The general contractor is to arrange and coordinate all incoming and outgoing electrical and mechanical services for this project.
- F. The general contractor is to coordinate all activities as required to ensure efficient, correct and orderly installation of each part of the project and to avoid conflict in the trade work and schedule.
- G. Shop drawings detailing engineered floor, beam/lintels, and trusses are required to be submitted on site for the framing inspection.
- H. All doors and windows referenced on plans and schedules are shown nominal size. Confirm and verify all rough opening size requirements with the selected product manufacturer and site conditions prior to fabrication.
- I. Provide and install solid blocking and backing within the walls for all washroom accessories, handrails, guards, ladders, mechanical and electrical fixtures and equipment, etc. as required for proper anchoring.
- J. All construction to comply with industry trade standards, as well as manufacturers' recommendations, to the extent that those instructions and recommendations are explicit or stringent as the requirements contained in these contract documents.
- K. Confirm all rough opening sizes and connection requirements for mechanical, electrical, and owner supplied equipment. adjust rough opening sizes to suit.
- L. Install owner supplied equipment as directed, centered, level and true.
- M. Provide all warranties, bonds, and manufacturer's operating instruction and service manuals as well as parts lists at the completion of the project.
- N. Do not scale drawings.
- O. Any penetrations through the main floor assembly will be required to be provided with rated fire stop as it is considered a membrane only system as per sentence 3.1.9.1.(3).
- P. Safety glass to be provided on tub & shower enclosures, guards, entry doors and sidelights
- Q. Provide water resistant flooring in bathrooms, kitchens, entrances, and laundry.
- R. Provide waterproof wall finish full height in tubs and showers.
- S. Site drainage as per city of saskatoon.
- T. All structural systems for a building that are within the scope of part 3 or 4 of NBCC must be signed and sealed by a professional engineer.
- U. Shop drawings are required for floor and roof trusses, i-joists and web trusses, laminated beams, windows and doors, all shop drawings to be reviewed and approved by designer.

#### CONSTRUCTION NOTES:

- A. Vapour barrier must conform to CAN/CGSB-51-34.
- B. Eave protection must be provided for the first 36" under shingles.
- C. Attic space shall be vented. Vents must have a combined area of 1/300 of the insulated ceiling space. If the roof slope is less than 1:6 then the area shall be increased to 1/150.
- D. Wall and roof sheathing must be edge nailed at 6" oc and field nailed at 12" oc.
- E. Wood framing members that are not pressure treated must be at least 6" above grade.
- F. Provide and install hurricane ties on roof trusses.
- G. Pre-engineered trusses must be designed for this specific building and installed according to the truss manufacturer's literature.
- H. All lumber must be spf #2 or better and installed according to NBCC.
- I. The size of all lintels must conform to table a-12 to a-15 of the nbc 2010. Spans more than 9'-0" must have double Jack studs on either side of the header, secure jack studs to full length studs with double nailing 16" oc.
- J. Handrails are required for all stairs with more than 2 risers inside or 3 risers outside. The height of handrails shall not be less than 31.5" and not more than 38". Handrails must be securely fastened.
- K. Each bedroom must have at least one window which opens and have an unobstructed area of .35sgm. No dimensions of this opening can be less than 15". Awning windows do not meet egress requirements.
- L. Electrically operated smoke alarms and carbon monoxide detectors must be provided on all floors and in each bedroom. Alarms must be interconnected and hardwired.
- M. Ensure a ventilation system is provided and conforms to the requirements of NBCC 9.32 or CAN/CSA-F326-M91.
- N. Make up air is required for any appliances that exhausts more than 75 L/
- O. Topsoil and vegetation material in all un-excavated materials under a building shall be removed.
- P. Wood in contact with concrete must be separated by a sill gasket or 6mil
- Q. The perimeter and all penetrations must of the basement floor slab must be sealed with caulking to prevent soil gas leakage.
- R. Sump pits must be not less than 29.5" deep, not less than 0.24m2 in area, be provided with a cover, have an automatic pump and be connected to sewer, drainage ditch or dry well.
- S. All floor, wall, and roof framing as per NBCC 9.23.
- T. All stairs to conform to NBCC section 9.8.

#### **WALL & PARTITION NOTES:**

- A. All interior walls extend to U/S of structure unless noted otherwise.
- B. For stud spacing, lintel sizes, joist spacing & other related information, refer to structural drawings.
- C. Around all showers & tubs with shower facility, provide substrate suited to tile installation as noted on plans.

## ROOF ASSEMBLIES:

- A. All down spouts from leaders to be located as shown on plans and
- B. Provide proper metal flashing at all required locations.

#### SUGGESTED SUSTAINABLE DESIGN:

- A. Install LED lights.
- B. Install low-flow plumbing fixtures.
- C. Install occupancy sensors on all light fixtures.
- D. Install main kill electrical switch @ front door.
- E. Install programmable thermostat.
- F. Insulate water heater.
- G. Insulate water pipes.
- H. Seal all duct work.
- I, Use low-VOC paints.
- J. Install triple pane, low-e, argon filled windows.
- K. Install solar heating.
- L. Plant native plants for landscaping.
- M. Install water filter at kitchen tap.
- N. Provide recycling and compost bins in kitchen.
- O. Provide EnergyStar appliances.
- P. Use lighter coloured shingles (cool roof).
- Q. Install eco-friendly countertop.
- R. Use linoleum instead of vinvl flooring.
- S. Install natural carpeting
- T. Use FSC wood.
- U. Use composite material for decking.
- V. Install rain-water collection barrels.
- W. Install drain-water heat recovery.
- X. Substitute fly-ash for cement in concrete.

## **BUILDING CODE ANALYSIS**

THE FOLLOWING NOTES PROVIDE INFORMATION HIGHLIGHTING BUILDING DESIGN CRITERIA. IT IS NOT INTENDED TO DESCRIBE ALL DESIGN & CONSTRUCTION REQUIREMENTS, ALL CONSTRUCTION SHALL CONFORM TO ALL APPLICABLE SECTIONS OF THE BUILDING CODE.

. PROPOSED BUILDING CONSTRUCTED UNDER PART 9 OF THE NATION BUILDING CODE 2015.

2 MAJOR OCCUPANCIES:

GROUP C - DWELLING UNIT

3. BUILDING HEIGHT: 2 STOREY

. BUILDING AREAS:

PROPOSED BUILDING

1st FLOOR 2nd FLOOR 972 ft2 TOTAL: 2241 ft<sup>2</sup>

- 5. ALL FLOORS ARE NON-SPRINKLERED.
- 6. SIZE & CONSTRUCTION RELATIVE TO OCCUPANCY:

. CLIMATIC DESIGN DATA: SNOW LOAD DATA: Ss = 1.7kPA Sr = 0.1 kPa HOURLY WIND PRESSURE: q/50 = 0,48kPa

8. CLEARANCES:

EXITS: HEADROOM 2050mm STAIRS: HEADROOM 1950mm / LANDINGS 2050mm DOORWAYS: 860mm

9. ROOFS:

ROOF SOFFITS NOT ALLOWED WITHIN 0.45m OF PROPERTY LINE.9.10.15.5. (7) NO VENTED SOFFITS WITHIN 1.2m OF PROPERTY LINE. 9.10, 15.5. (10)

DISCLAIMER

These plans are drawn to comply with the Client's and/or Builder's specifications and any changes made to the drawings after prints are issued will be done at the Client's and/or Builder's expense and responsibility. The Builder shall verify all dimensions and enclosed drawings and other details prior to construction and be solely responsible thereafter, B.L.D.G. STUDIO Inc. is not liable for errors once construction has begun. While every effort has been made in the preparation of this plan to avoid mistakes, B.L.D.G. STUDIO INC. cannot guarantee against human

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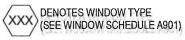
#### LEGEND




DENOTES CONSTRUCTION TYPE (SEE CONSTRUCTION TYPES A101)



DENOTES DOOR TYPE (SEE DOOR SCHEDULE A801)



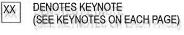



EFERS TO DETAIL NUMBER

REFERS TO DRAWING NUMBER

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ROBICHAUD/THOMSON RESIDENCE

221 10th STREET E BUILT BY: OTM HOMES

SHOP DRAWING APPROVAL

DRAWN BY: CMB PROJECT NO: 1895

**DATE: APRIL 18, 2019** SCALE: AS SHOWN/11x17 LAYOUT ISSUED: CLIENT REVIEW

GENERAL INFORMATION

#### **CONCRETE PROPERTIES:**

ALL CAST-IN-PLACE CONCRETE WORK IN ACCORDANCE WITH CSA-A23.1.

#### FOUNDATION WALL:

2-10M @ TOP, MID, BTM HORIZ, 15M @ 24"oc VERT INSIDE FACE, 25 MPa, TYPE HS CEMENT (ASSUMED 7' HIGH BACK FILL)

#### PILES:

25 MPa, TYPE HS CEMENT P1: 8" DIA, 15'-0" DEEP 2-15M FULL HT

#### STRIP FOOTINGS:

24"x8" 25 MPa, TYPE HS CEMENT, R/W 4-10M REBAR CONT.

#### FOOTINGS:

20 MPa, TYPE HS CEMENT

F1: MEDIUM LOADING: 44"x44"x8" CONC PAD R/W 4-15M E.W. @ BTM (UP TO 20,000 LBS)

#### **BASEMENT CONCRETE SLAB:**

3" CONC SLAB 20 MPa, TYPE HS CEMENT

# **FOUNDATION NOTES:**


- 1. FLEXIBLE SEALANT IS REQUIRED AROUND THE PERIMETER OF THE CONCRETE FLOOR AND AT ALL FLOOR PENETRATIONS.
- 2. RADON TRAP REQUIRED FOR WEEPING TILE. 3. ROUGH-IN DEPRESSURIZATION SYSTEM REQUIRED TO NBC 9.13.4.3.
- 4. WHERE GROUND WATER IS LESS THAN THE WIDTH OF THE FTG BELOW TE BEARING SURFACE, THE WIDTH OF THE STRIP FTG SHALL BE DOUBLED AND THE AREA OF THE COLUMN FTG SHALL EB DOUBLED AS PER NBC 9.15.3.4.3. 5. INSTALLATION OF A SUMP PUMP IS REQUIRED IN CONFORMANCE TO COS REQUIREMENTS 6. CONCRETE PROPERTIES MUST CONFORM TO NBC 9.3.

#### PILE NOTE:

THE CAST-IN-PLACE CONCRETE PILE DESIGN IS BASED ON THE ASSUMPTION THAT THE SOIL IS COHESIVE (CLAY OR TILL) AND HAS A MINIMUM SKIN FRICTION CAPACITY OF 20 kPa. IF THE CONTRACTOR OBSERVES A SOIL THAT IS COHESIONLESS (SAND OR SILT), CONCRETE PILES MAY NOT BE APPROPRIATE. ALSO, IF THE PILES ARE PLACED IN FILL MATERIAL MORE THAN 6' IN DEPTH, THE PILE SHOULD BE LENGTHENED BY THE FILL DEPTH GREATER THAN 6'.

## **FOOTING NOTE**

FOOTING TO BEAR ON PREVIOUSLY UNDISTURBED SOIL. ANY OVER EXCAVATION SHALL BE FILLED WITH CONCRETE DO NOT CAST FOOTING ON FROZEN SOIL AND DO NOT ALLOW SOIL BELOW FOOTING TO FREEZE THEREAFTER.

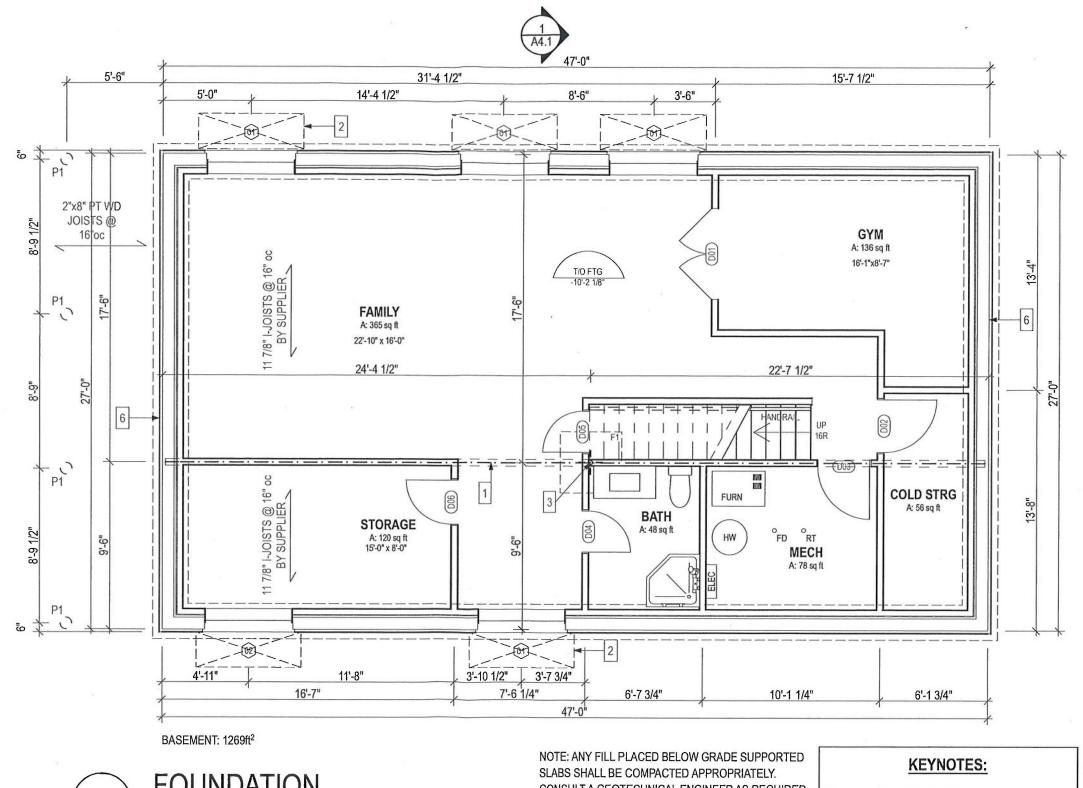

FOUNDATION SCALE: 3/16" = 01'-0'

CONSULT A GEOTECHNICAL ENGINEER AS REQUIRED.

# REINFORCING STEEL

1. TO CSA STANDARD G.30.18, GRADE 400, PLAIN FINISH FOR ALL BARS UNLESS NOTED OTHERWISE. MINIMUM SPLICE FOR 10M AND 15M BARS TO BE

2. PERFORM CONCRETE REINFORCING WORK IN ACCORDANCE WITH CAAN/CSA-A23.3 "DESIGN OF CONCRETE STRUCTURES".

LVL BY SUPPLIER

WINDOW WELL DRAIN TO SUMP

[3] 3" ADJ STEEL COLUMN

2

4

[5]

6

7

5.5"x5.5" SPF WD POST

6"x6" PT WOOD POST

2"x10" PTWD LEDGER C/W 1/2"

ANCHOR BOLTS @ 16"oc

3-2"x10" PT WD BEAM

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BUILT BY: OTM HOMES

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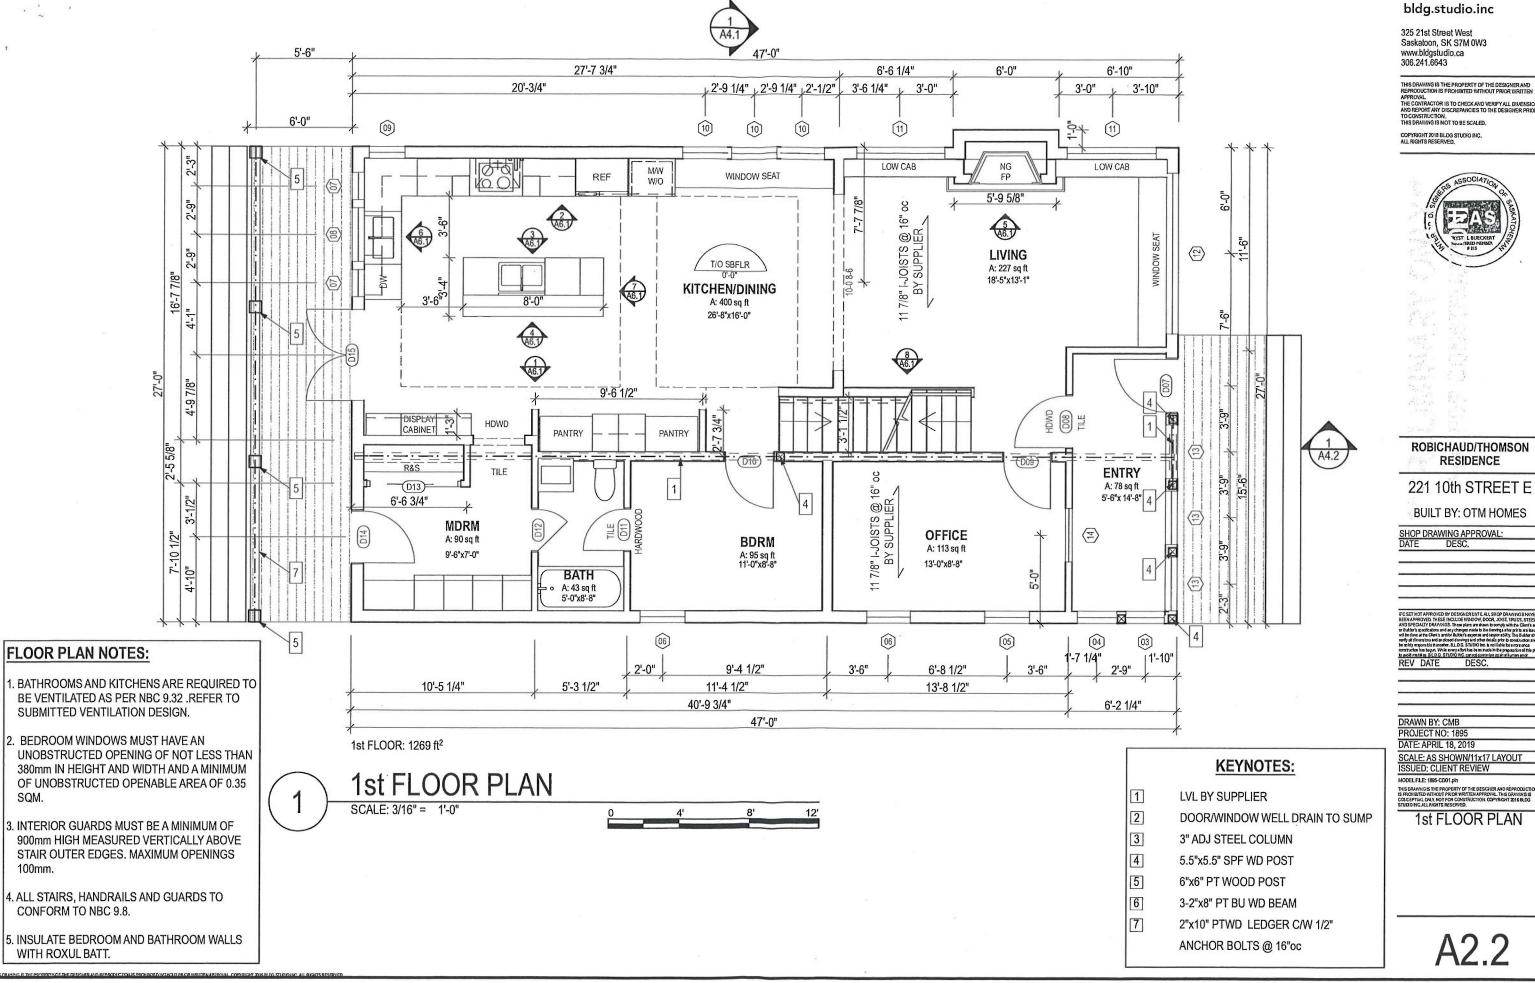
REV DATE DESC.

DRAWN BY: CMB PROJECT NO: 1895 **DATE: APRIL 18, 2019** 

SCALE: AS SHOWN/11x17 LAYOUT ISSUED: CLIENT REVIEW

**FOUNDATION** 


A2.1





# FLOOR PLAN NOTES:

- BATHROOMS AND KITCHENS ARE REQUIRED TO BE VENTILATED AS PER NBC 9.32 .REFER TO SUBMITTED VENTILATION DESIGN.
- 2. BEDROOM WINDOWS MUST HAVE AN UNOBSTRUCTED OPENING OF NOT LESS THAN 380mm IN HEIGHT AND WIDTH AND A MINIMUM OF UNOBSTRUCTED OPENABLE AREA OF 0.35 SQM.
- 3. INTERIOR GUARDS MUST BE A MINIMUM OF 900mm HIGH MEASURED VERTICALLY ABOVE STAIR OUTER EDGES. MAXIMUM OPENINGS 100mm.
- 4. ALL STAIRS, HANDRAILS AND GUARDS TO CONFORM TO NBC 9.8.
- 5. INSULATE BEDROOM AND BATHROOM WALLS WITH ROXUL BATT.

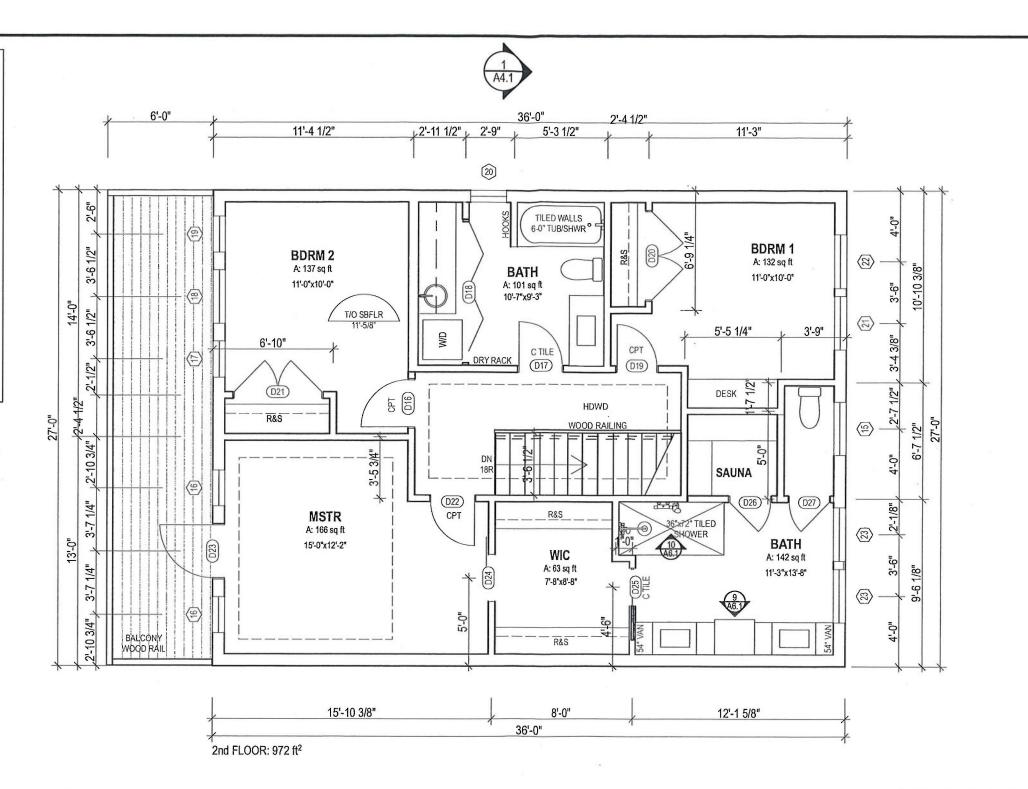

2nd FLOOR PLAN

SCALE: 3/16" = 1'-0"



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221 10th STREET E

BUILT BY: OTM HOMES

SHOP DRAWING APPROVAL:
DATE DESC.

REV DATE DESC.

DRAWN BY: CMB PROJECT NO: 1895 DATE: APRIL 18, 2019

SCALE: AS SHOWN/11x17 LAYOUT ISSUED: CLIENT REVIEW

2nd FLOOR PLAN

**KEYNOTES:** 

- LVL BY SUPPLIER
- DOOR/WINDOW WELL DRAIN TO SUMP
- 3" ADJ STEEL COLUMN
- 4 5.5"x5.5" SPF WD POST
- 2"x10" PTWD LEDGER C/W 1/2"

5 6"x6" PT WOOD POST

6 3-2"x8" PT BU WD BEAM [7]

ANCHOR BOLTS @ 16"oc

A2.3

