Planning and Development
222 3<sup>rd</sup> Avenue North
Saskatoon SK S7K 0J5

www.saskatoon.ca tel (306) 975-2645 fax (306) 975-7712

**R.1** 

February 27, 2025

Graham Figg BelleMaison Development Corp 231 Feheregyhazi Blvd Saskatoon, SK S7W 1G8

# **SENT VIA EMAIL**

Re: Development Permit Denial: NHS-2025-00923

Proposal: New One Unit Dwelling

Site Address: 303 Evergreen Boulevard

Zoning District: RMTN - Townhouse Residential District

The Planning and Development Division has reviewed your submitted Building and Development Permit application. After review, the following deficiencies have been noted with the City of Saskatoon's Zoning Bylaw 9990:

1. <u>Requirement</u>: Section 8.8.2 states a one unit dwelling requires a minimum front yard building setback of 6 metres.

Proposed: A front yard setback of 0.997 metres is proposed.

<u>Deficiency</u>: This results in a front yard setback deficiency of 5.003 metres.

2. <u>Requirement</u>: Section 8.8.2 states the site coverage maximum for a one unit dwelling is 40%.

Proposed: A site coverage of 40.995% is proposed.

<u>Deficiency</u>: This results in 0.995% over the maximum permitted site coverage.

As consequence, the Planning and Development Division cannot approve your plans for a Development Permit.

Should you wish, you may appeal this decision to the Development Appeal Board. To proceed with a appeal request please fill out the online Development Appeal application form available through the following link: <a href="https://capps.saskatoon.ca/development-appeals/">https://capps.saskatoon.ca/development-appeals/</a> within 30 days of the date of this letter. Note there is a application fee of \$50 for this process. Attached to this email is general information about the Development Appeal process, as well as a extract from the Planning and Development Act 2007.

Alternatively, to continue with your application you may submit revised drawings that address the above points for further review within 30 days of the date of this letter to the online permit portal.

If you have any questions about this information, please let me know.

Sincerely,

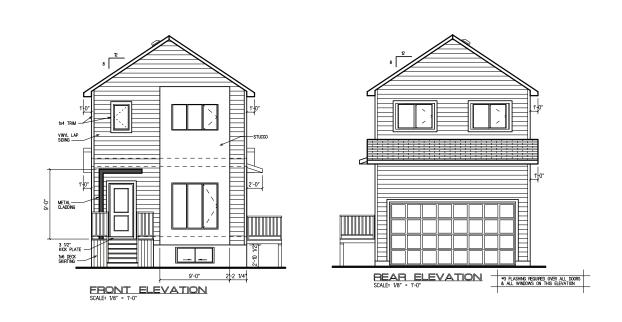
Vanessa Champagne

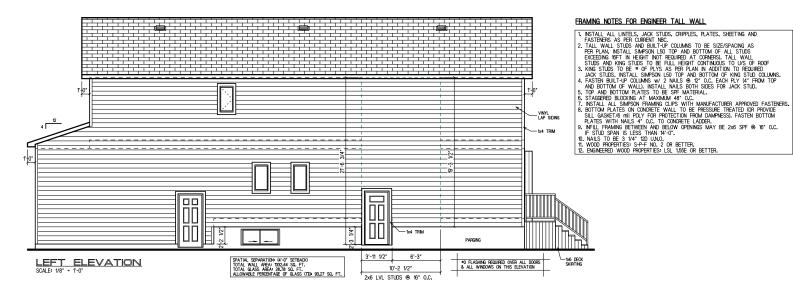
Planning and Development Division (306-975-2659)

vanessa.champagne@saskatoon.ca

cc: Brent McAdam, Planning and Development

Development Appeal Board Secretary, City Clerks





NOTE! NO VENTED SOFFITS WITHIN 12m OF THE PROPERTY LINE, PROTECT SOFFITS AS PER NBC, 93.0.5.5.00, DISURE MIN, 282 OF ROOF USE LOW ROOF WHIT AT LINE WITH SAS REQUIRED BY OWNER MULLITED SO\* UP FROM FASCIA)

### EXTERIOR FINISH AS PER SPEC.

GRADE IS ONLY SUGGESTED AND MUST BE ADJUSTED TO SUIT INDIVIDUAL SITE CONDITIONS. ADJUST CONCRETE STEPS TO SUIT GRADE.

# BELLE MAISON DEVELOPMENT CORPORATION

**A**1

## 303 EVERGREEN BLVD.

CUSTOM K24028

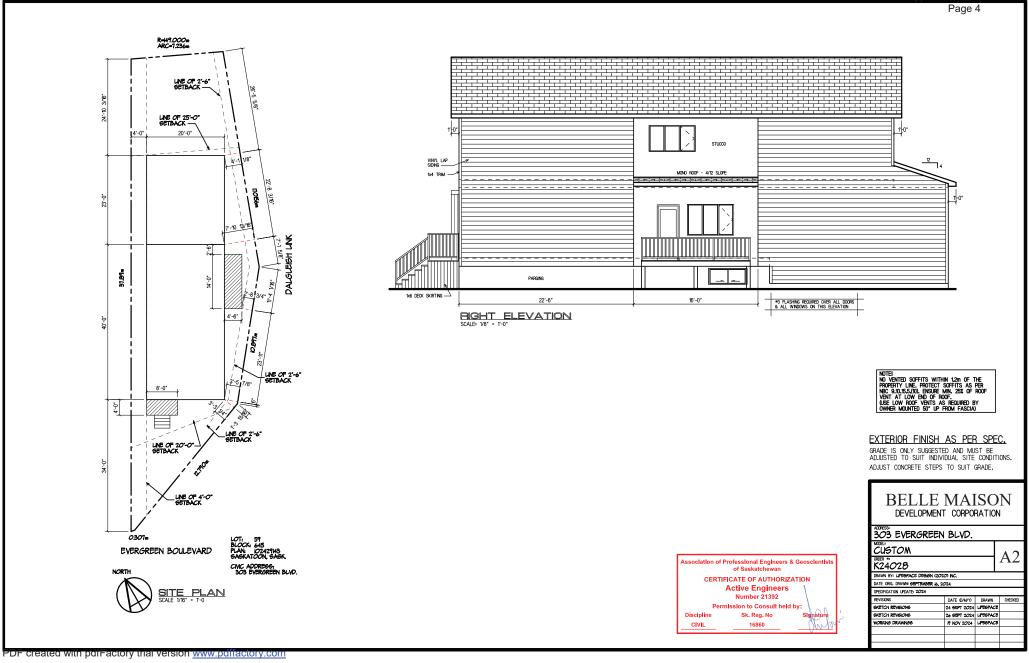
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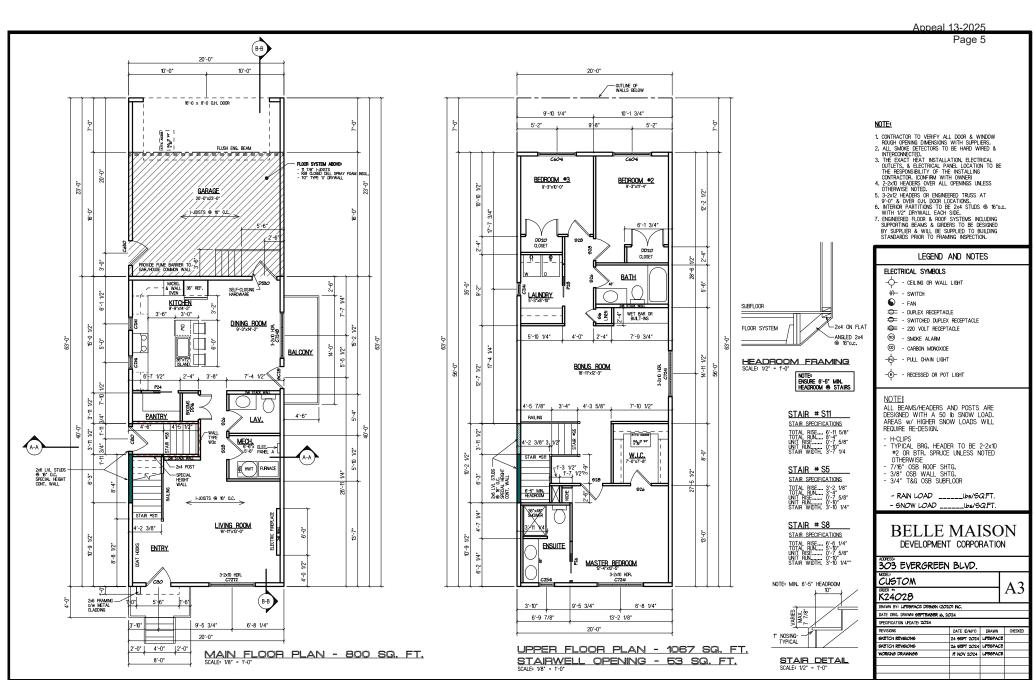
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SPECIFICATION UPDATE: 2024
REVISIONS

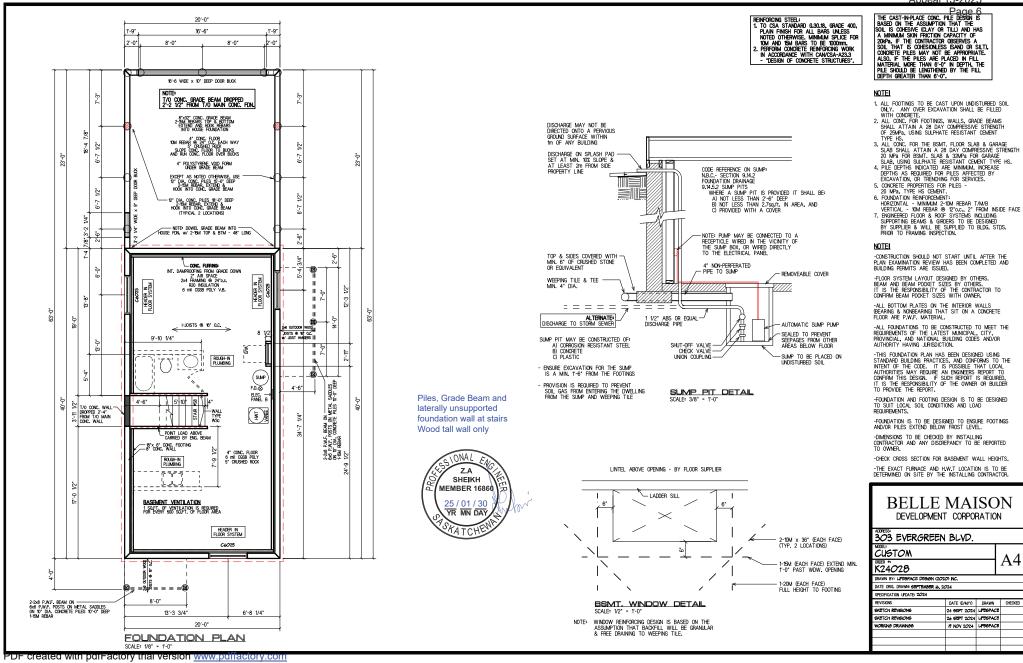
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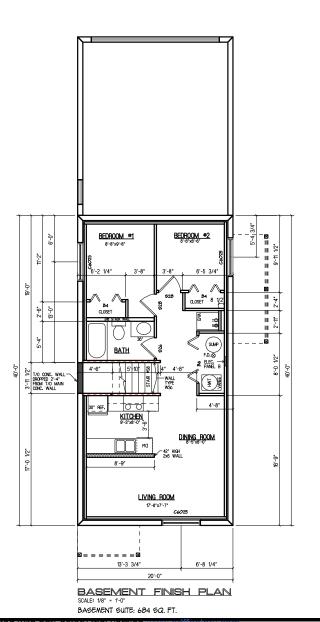






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FLOOR TYPE F8h (30 MIN, FRR, 48 STC)

3/4" OSB SUBFLOOR BNG, JOISTS BY SUPPLIER (MAX. 24" O.C.) FIBREGLASS BATT INSULATION RESILIANT METAL CHANNELS © 16" O.C. 1 LAYER 1/2" TYPE X DRYWALL

PRINCIPAL RESIDENCE

FRAME WALL BETWEEN -ALL JOIST CAVITIES FIRE CAULK AT JOISTS PRINCIPAL RESIDENCE WALL TYPE W30 (45 MIN. FRR. 43 STC)

1 LAYER 1/2" TYPE X DRYWALL
2/4 STUDS @ 6" 0.C.
FIBREGLASS BATT INSILATION
FESILIANT METAL CHANGES @ 24" 0.C. HORIZ.
1 LAYER 1/2" TYPE X DRYWALL

FIRE SEPARATION DETAIL SCALE: 1/2" = 1'-0"

WALL TYPE W30: (45 MIN, FFR. 43 STC)

1 LAYER 1/2" TYPE X DRYWALL
2/4 STUDS @ 16" O.C.
FIBREGLASS BATT INSILATION
FESILIANT METAL CHAMPLES @ 24" O.C. HORIZ.

1 LAYER 1/2" TYPE X DRYWALL SUITE

PRINCIPAL RESIDENCE

FIRE SEPARATION - PLAN SCALE: 1/2" = 1'-0"

ALL DIMENSIONS MEASURED TO ROUGH OPENING SIZES AND TO BE CONFIRMED BEFORE FRAMING. OPENING SCHEDULE TO BE USED AS A GUIDE ONLY.

OPENING SCHEDULE									
NAME	TYPE	QTY.	SWING	HAND	WIDTH	HEIGHT	HEADER HEIGHT	DESCRIPTION	
16x8	EXTERIOR DOC	R 1	-	-	16'-3"	8'-1 1/2"	7'-7 1/2"	16x8 OH DOOR w/ 10" BUCK	
C130	EXTERIOR DOC	R 2	as per plan	as per plan	3'-2 1/4"	6'-10 5/8"	6'-10 5/8"	3'-0" EXT CLAD DOOR	
C630	EXTERIOR DOC	R 1	as per plan	as per plan	3'-2 1/4"	6'-10 5/8"	6'-5 5/8"	3'-0" EXT CLAD SERVICE DOOR w/ 9" BUCK	
D530	EXTERIOR DOC	R 1	as per plan	as per plan	3'-2 1/4"	6'-10 5/8"	6'-10 5/8"	3'-0" EXT CLAD DOOR w/ CLOSURE	
GC28	EXTERIOR DOC	R 1	as per plan	as per plan	2'-10 1/8"	6'-9 3/4"	6'-9 3/4"	1 PANEL CLAD GARDEN DOOR	
DD16	INTERIOR DOOR	1	as per plan	as per plan	3'-2 1/4"	6'-10 1/4"	6'-10 1/4"	2-1'-6" DBL. INTERIOR SWING DOORS	
P24	INTERIOR DOOR	1	as per plan	as per plan	4'-9"	7'-0 1/2"	7'-0 1/2"	2'-4"x6'-8" POCKET DOOR	
S26	INTERIOR DOOR	1	as per plan	as per plan	2'-8"	6'-10 1/4"	6'-10 1/4"	2'-6" INTERIOR SWING DOOR	
S28	INTERIOR DOOR	1	as per plan	as per plan	2'-10"	6'-10 1/4"	6'-10 1/4"	2'-8" INTERIOR SWING DOOR	
C2141	WINDOW	2	-	-	1'-8 1/2"	3'-4 1/8"	6'-11 3/8"	PLYGEM - RO: 20 1/2 x 40 1/8	
C7248	WINDOW	1	-	-	5'-11 5/8"	4'-0"	6'-11 3/8"	PLYGEM - RO: 71 5/8 x 48	
C7272	WINDOW	1	-	-	5'-11 5/8"	5'-11 5/8"	6'-11 3/8"	PLYGEM - RO: 71 5/8 x 71 5/8	

OPENING SCHEDULE								
NAME	NAME TYPE QTY. SWING		HAND	WIDTH	HEIGHT	HEADER HEIGHT	DESCRIPTION	
DD20	INTERIOR DOOR	2	as per plan	as per plan	4'-2 1/4"	6'-10 1/4"	6'-10 1/4"	2-2'-0" DOUBLE INTERIOR SWING DOORS
P26	INTERIOR DOOR	1	as per plan	as per plan	5'-1"	7'-0 1/2"	7'-0 1/2*	2'-6"x6'-8" POCKET DOOR
P28	INTERIOR DOOR	1	as per plan	as per plan	5'-5"	7'-0 1/2"	7'-0 1/2"	2'-8"x6'-8" POCKET DOOR
S16	INTERIOR DOOR	1	as per plan	as per plan	1'-8"	6'-10 1/4"	6'-10 1/4"	1'-6" INTERIOR SWING DOOR
S26	INTERIOR DOOR	2	as per plan	as per plan	2'-8"	6'-10 1/4"	6'-10 1/4"	2'-6" INTERIOR SWING DOOR
S28	INTERIOR DOOR	3	as per plan	as per plan	2'-10"	6'-10 1/4"	6'-10 1/4"	2'-8" INTERIOR SWING DOOR
C2141	WINDOW	1	-	-	1'-8 1/2"	3'-4 1/8"	6'-11 3/8"	PLYGEM - RO: 20 1/2 x 40 1/8
C2541	WINDOW	1	-	-	2'-0 3/8"	3'-4 1/8"	6'-11 3/8"	PLYGEM - RO: 24 3/8 x 40 1/8
C6041	WINDOW	2	-	-	4'-11 7/8"	3'-4 1/8"	6'-11 3/8"	PLYGEM - RO: 59 7/8 x 40 1/8
C7241	WINDOW	2	-	-	5'-11 5/8"	3'-4 1/8"	6'-11 3/8"	PLYGEM - RO: 71 5/8 x 40 1/8"

OPENING SCHEDULE										BASEMENT	FINISH	PLAN			
NAME	TYPE		QTY.	SWIN	IG	HA	ND		WIDTH	HEIGHT	HEADER HEIGHT	DESCRIPTION			
B4	INTERIOR	DOOR	2	as p	er plar	as	per	plan	4'-1 1/4"	6'-9 1/2"	6'-9 1/2"	4'-0" BI-FOLD			
B6	INTERIOR	DOOR	1	as p	er plar	as	per	plan	6'-1 1/4"	6'-9 1/2"	6'-9 1/2"	6'-0" BI-FOLD			$\neg$
S26	INTERIOR	DOOR	1	as p	er plar	as	per	plan	2'-8"	6'-10 1/4"	6'-10 1/4"	2'-6" INTERIOR SWIN	IG DOOR		
S28	INTERIOR	DOOR	2	as p	er plar	as	per	plan	2'-10"	6'-10 1/4"	6'-10 1/4"	2'-8" INTERIOR SWIN	IG DOOR		
C6025	WINDOW		3	-		-			4'-11 7/8"	2'-0 1/2"	8'-10"	PLYGEM - RO: 59 7	/8 x 24 1/2		

**BELLE MAISON** DEVELOPMENT CORPORATION

A5

303 EVERGREEN BLVD.

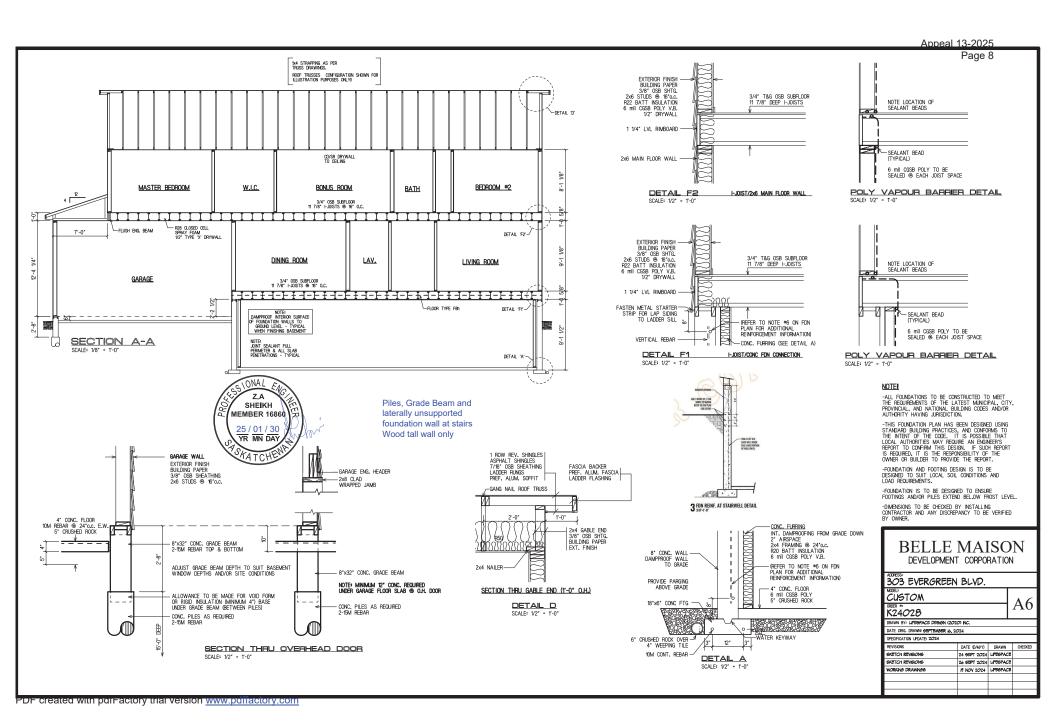
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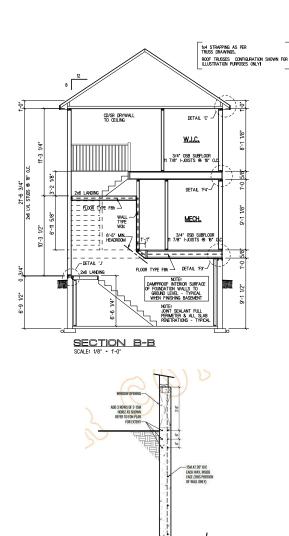
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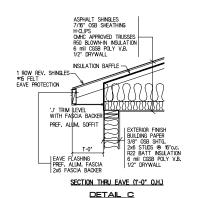
SPECIFICATION UPDATE: 2024 SKETCH REVISIONS

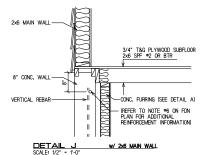
DATE (D/M/Y) DRAWN CHECKED 24 SEPT 2024 LIFESPACE SKETCH REVISIONS 26 SEPT 2024 LFESPACE WORKING DRAWINGE # NOV 2024 LIFESPACE

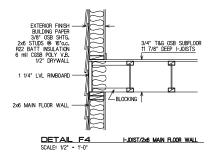
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EXTERIOR FINISH -BUILDING PAPER 3/8" OSB SHTG. 2x6 STUDS © 16"o.c. R22 BATT INSULATION 6 mil CGSB POLY V.B. 1/2" DRYWALL -RI OCKING 3/4" T&G OSB SUBFLOOR 11 7/8" DEEP I-JOISTS 1 1/4" LVL RIMBOARD FASTEN METAL STARTER— STRIP FOR LAP SIDING TO LADDER SILL - (REFER TO NOTE #6 ON FDN PLAN FOR ADDITIONAL REINFORCEMENT INFORMATION) VERTICAL REBAR CONC. FURRING (SEE DETAIL A) DETAIL F3 I-JOIST/CONC FDN CONNECTION SCALE: 1/2" = 1'-0"

Piles, Grade Beam and laterally unsupported foundation wall at stairs Wood tall wall only



#### NOTE

-ALL FOUNDATIONS TO BE CONSTRUCTED TO MEET THE REQUIREMENTS OF THE LATEST MUNICIPAL, CITY, PROVINCIAL, AND NATIONAL BUILDING CODES AND/OR AUTHORITY HAVING JURISDICTION.

-THIS FOUNDATION PLAN HAS BEEN DESIGNED USING STANDARD BULDING PRACTICES, AND CONFORMS TO THE NITHER OF THE CODE. IT IS POSSIBLE THAT LOCAL AUTHORITIES MAY REQUIRE AN BININER'S REPORT TO CONFIRM THIS DESIGN. IF SUCH REPORT SECURED, IT IS THE REPORT SHOUNDER OF BULDER TO PROVIDE THE REPORT OF THE OWNER OF BULDER TO PROVIDE THE REPORT.

-FOUNDATION AND FOOTING DESIGN IS TO BE DESIGNED TO SUIT LOCAL SOIL CONDITIONS AND LOAD REQUIREMENTS.

-FOUNDATION IS TO BE DESIGNED TO ENSURE FOOTINGS AND/OR PILES EXTEND BELLOW FROST LEVEL.

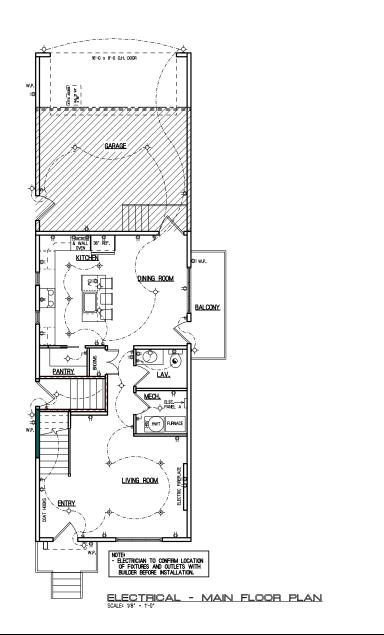
-DIMENSIONS TO BE CHECKED BY INSTALLING CONTRACTOR AND ANY DISCREPANCY TO BE VERIFIED BY OWNER.

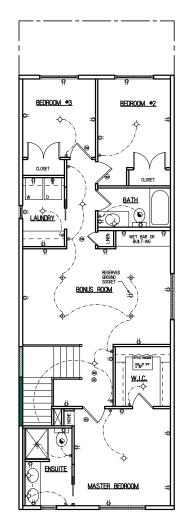


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3 FDN REINF. AT STAIRWELL DETAIL

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ELECTRICAL - UPPER FLOOR PLAN SCALE: 1/8" · 1-0"

#### LEGEND AND NOTES

# ELECTRICAL SYMBOLS

- - CEILING OR WALL LIGHT

€)- - SWITCH

FAN

- DUPLEX RECEPTACLE

- SWITCHED DUPLEX RECEPTACLE

● - 220 VOLT RECEPTACLE

◎ - SMOKE ALARM

- CARBON MONOXIDE

- - PULL CHAIN LIGHT

-R- - RECESSED OR POT LIGHT

ALL BEAMS/HEADERS AND POSTS ARE DESIGNED WITH A 50 Ib SNOW LOAD. AREAS W/ HIGHER SNOW LOADS WILL REQUIRE RE-DESIGN.

- H-CLIPS
   H-CLIPS
   TYPICAL BRG. H-EADER TO BE 2-2x10
  #2 OR BTR. SPRUCE UNLESS NOTED
  OTHERWISE
   71/8° OSB ROOF SHTG.
   3/8° OSB WALL SHTG.
   3/4° T&G OSB SUBFLOOR

- RAIN LOAD \_\_\_\_\_lbs/5Q.FT.

- SNOW LOAD \_\_\_\_\_lbs/SQ.FT.

# **BELLE MAISON** DEVELOPMENT CORPORATION

#### 303 EVERGREEN BLVD.

CUSTOM K24028

**A8** 

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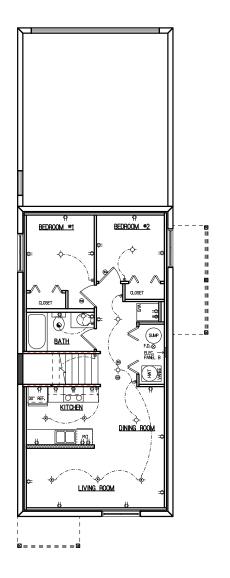
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ı	SKETCH REVISIONS	24 SEPT 2024	LFEGPACE	
ı	SKETCH REVISIONS	26 SEPT 2024	LFESPACE	
ı	WORKING DRAWINGS	IR NOV 2024	LFESPACE	
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Appeal 13-2025

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BELLE MAISON DEVELOPMENT CORPORATION

303 EVERGREEN BLVD.

CUSTOM K24*O*28

A9

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SPECIFICATION UPDATE: 2024

GKETCH REVISIONS

DATE (D/M/Y) DRAWN CHECKED
24 SEPT 2024 LIFBSPACE SKETCH REVISIONS 26 SEPT 2024 LIFESPACE WORKING DRAWINGS # NOV 2024 LIFESPACE

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