**Planning and Development** 222 3rd Avenue North Saskatoon SK S7K 0J5

www.saskatoon.ca 12-2025 Page 1 tel (306) 975-2645 fax (306) 975-7712

March 25, 2025

**R**<sub>-</sub>1

Rod Sawatzky



### **SENT VIA EMAIL**

Re: Development Permit Denial: NHS-2024-09117

> Proposal: New One Unit Dwelling Site Address: 1205 Spadina Cres E

Neighbourhood: North Park (Category 1 Established Neighbourhood)

Zoning District: R2 – Low Density Residential District 2

The Planning and Development Division has reviewed your Building and Development Permit application for an Accessory Building. After review, the following deficiency has been noted with the City of Saskatoon's Zoning Bylaw 9990:

1. Requirement: Section 8.4.4 (3)(a) states:

"The front yard setback requirement for OUDs, TUDs, SDDs and MUDs containing up to four dwelling units in established neighbourhoods shall not vary by more than 3 metres from the average front yard setback of the principal buildings on adjacent flanking sites, provided that in no case shall the setback be less than 6 metres."

The adjacent properties have existing front yard setbacks of:

1207 Spadina Cres E = 13.21m 1203 Spadina Cres E = 10.27m

Average = 11.74m

Based on the average front yard setback of the adjacent properties (11.74m), the minimum front vard setback shall not be less than 8.74m (11.74m – 3m).

Proposed: The proposed One Unit Dwelling has a front yard setback of 6.555m.

Deficiency: This proposed front yard setback is deficient 2.185m (7.168ft).

2. Requirement: Section 8.4.2 states the minimum rear yard setback for a One Unit Dwelling on an interior site is 7.5m.

Proposed: The proposed One Unit Dwelling has a rear yard setback of 4.775m.

Deficiency: This proposed front yard setback is deficient 2.725m (8.94ft).

As consequence, the Planning and Development Division cannot approve your plans for a Development Permit.

I understand you wish to appeal this decision to the Development Appeal Board. To proceed with a appeal request please fill out the online Development Appeal application form available through the following link: https://capps.saskatoon.ca/development-appeals/ within 30 days of the date of this letter. Note there is an application fee of \$50 for this process. Attached to this email is general information about the Development Appeal process, as well as an extract from the Planning and Development Act 2007.

If you have any questions about this information, please let me know.

Sincerely,

Wes Holowachuk

pla pholowoodish


Planning and Development Division (306-975-7905)


Wes.Holowachuk@Saskatoon.ca

CC:

Brent McAdam, Planning and Development Development Appeal Board Secretary, City Clerks

Winston Mah, Property Owner

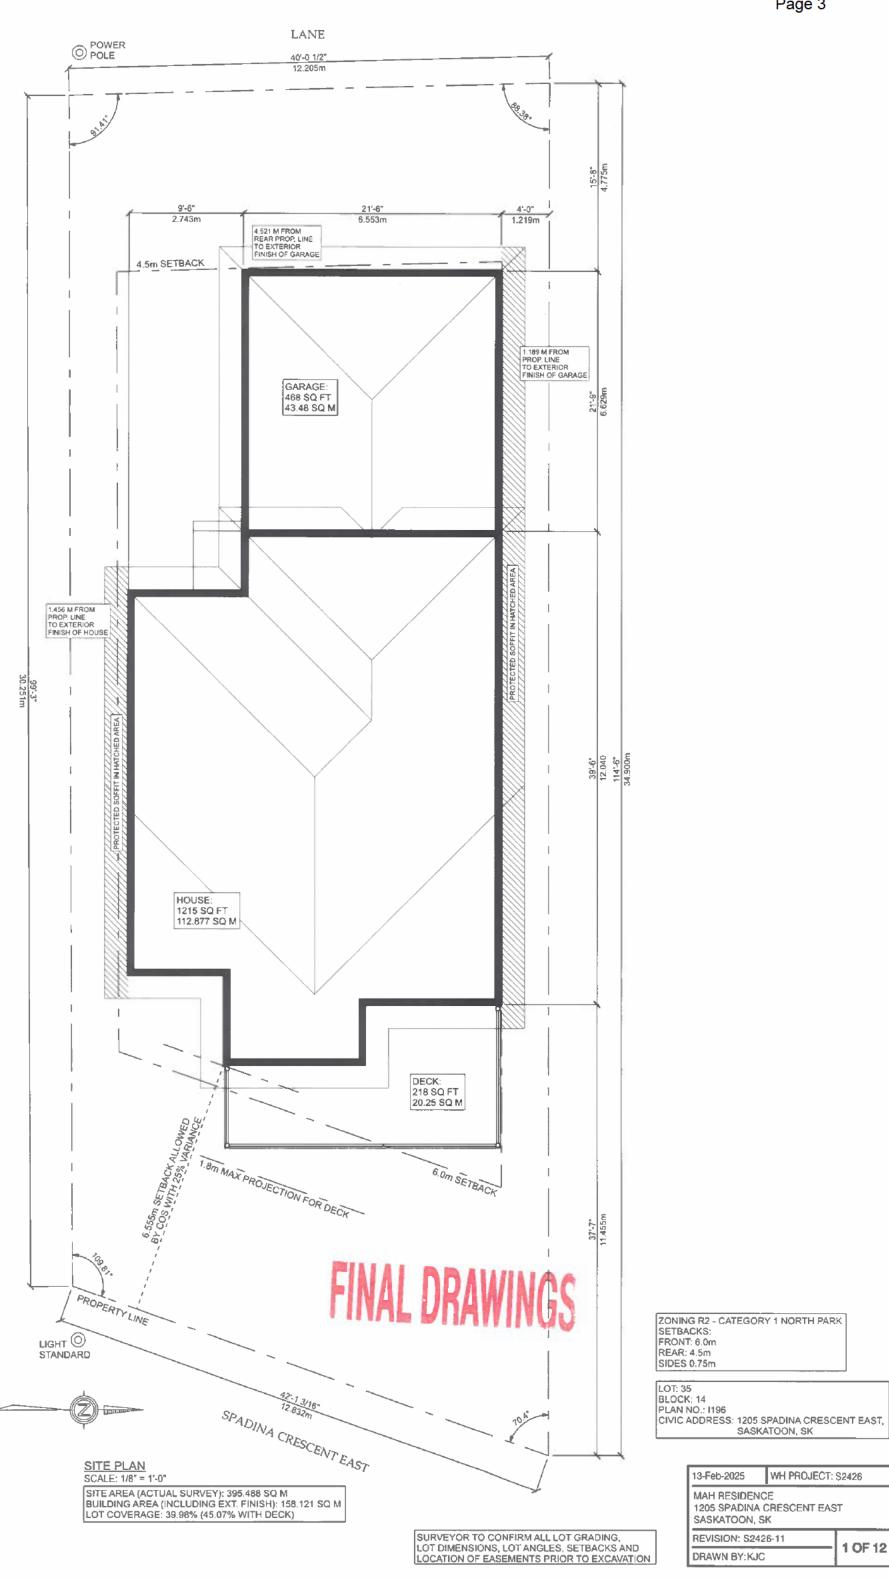


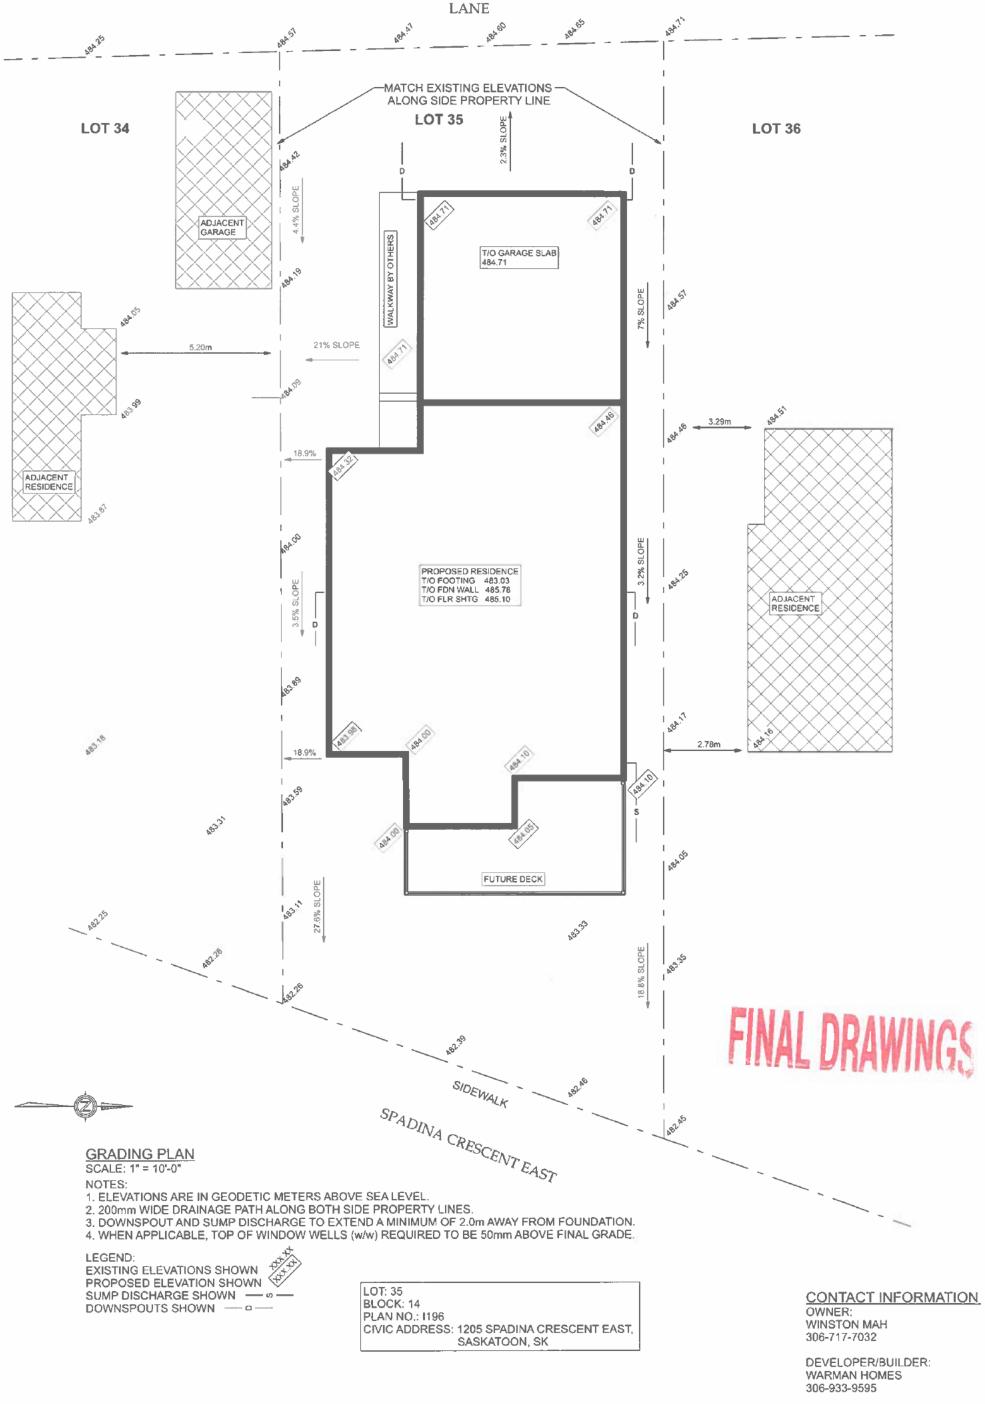

13-Feb-2025 WH PROJECT: S2426

MAH RESIDENCE
1205 SPADINA CRESCENT EAST
SASKATOON, SK

REVISION: S2426-11 DRAWN BY:KJC

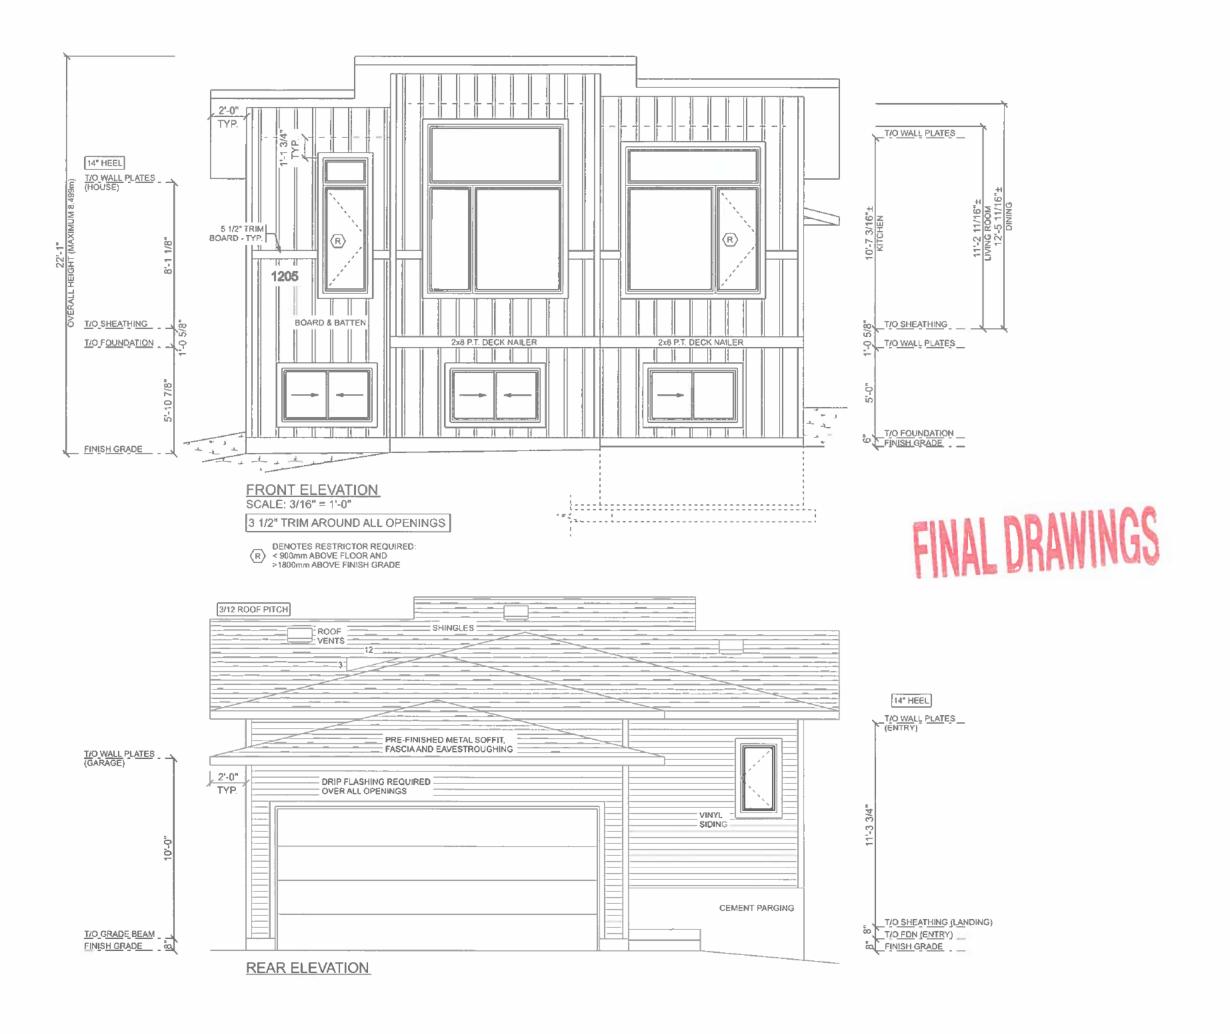

# Appeal 12-2025


18-Feb-2025	WH PROJECT S	WH PROJECT: \$2426	
REVISION	DATE	BY	
SDC	06 SEP 2024	KJC	
S2426-7	10 OCT 2024	CBU	
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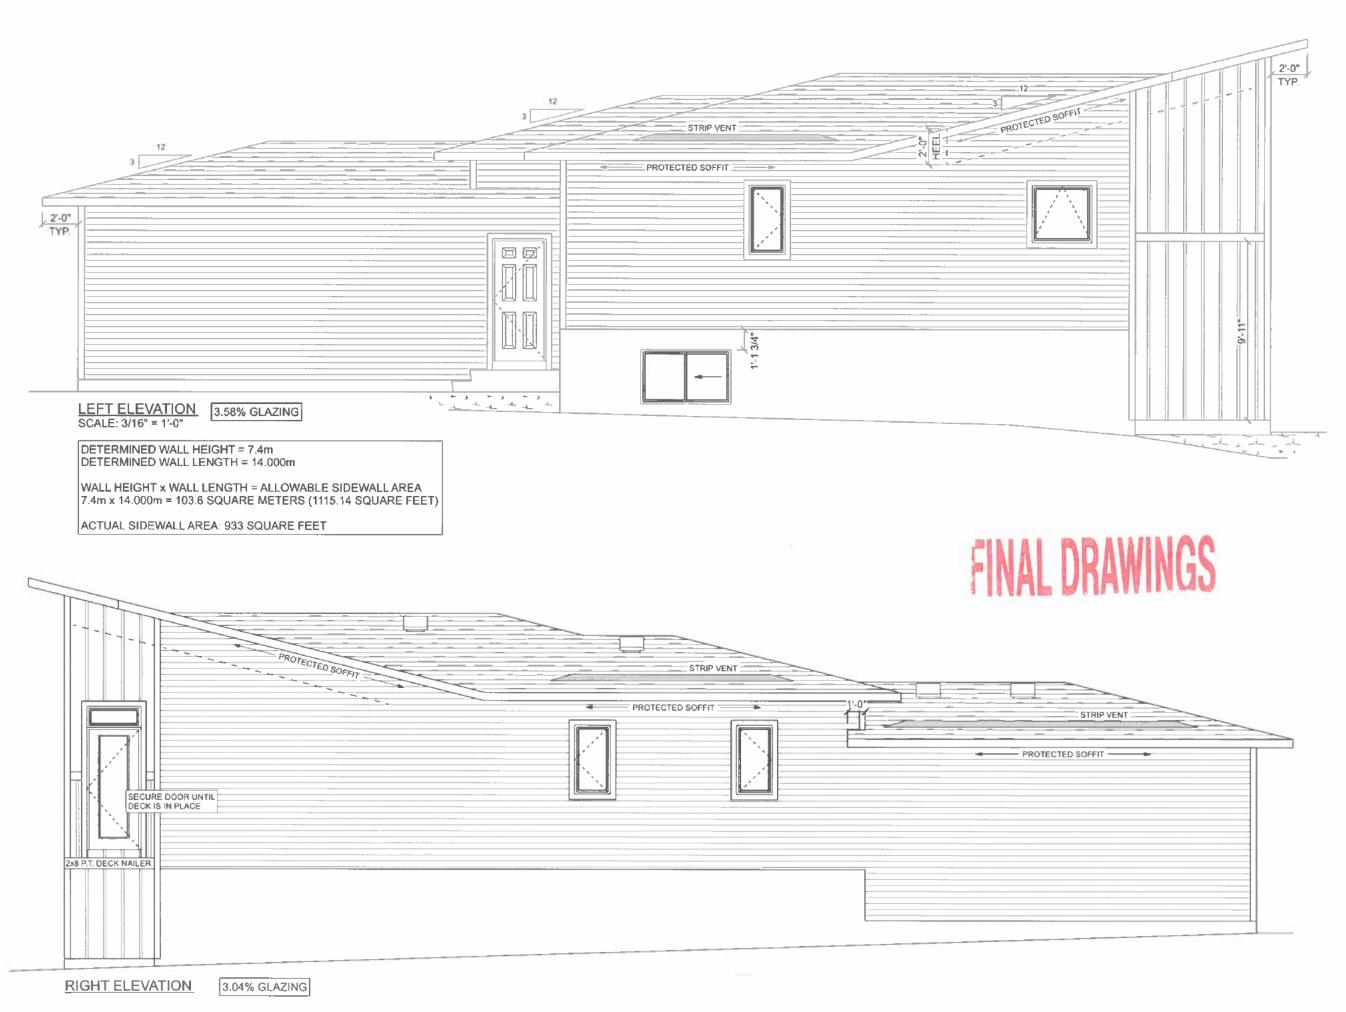




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MAH RESIDENCE 1205 SPADINA CRESCENT EAST SASKATOON, SK

SIZE: 1215 SQ FT DRAWN BY: KJC

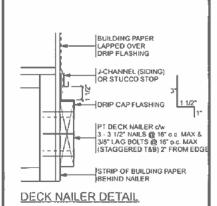

# Appeal 12-2025

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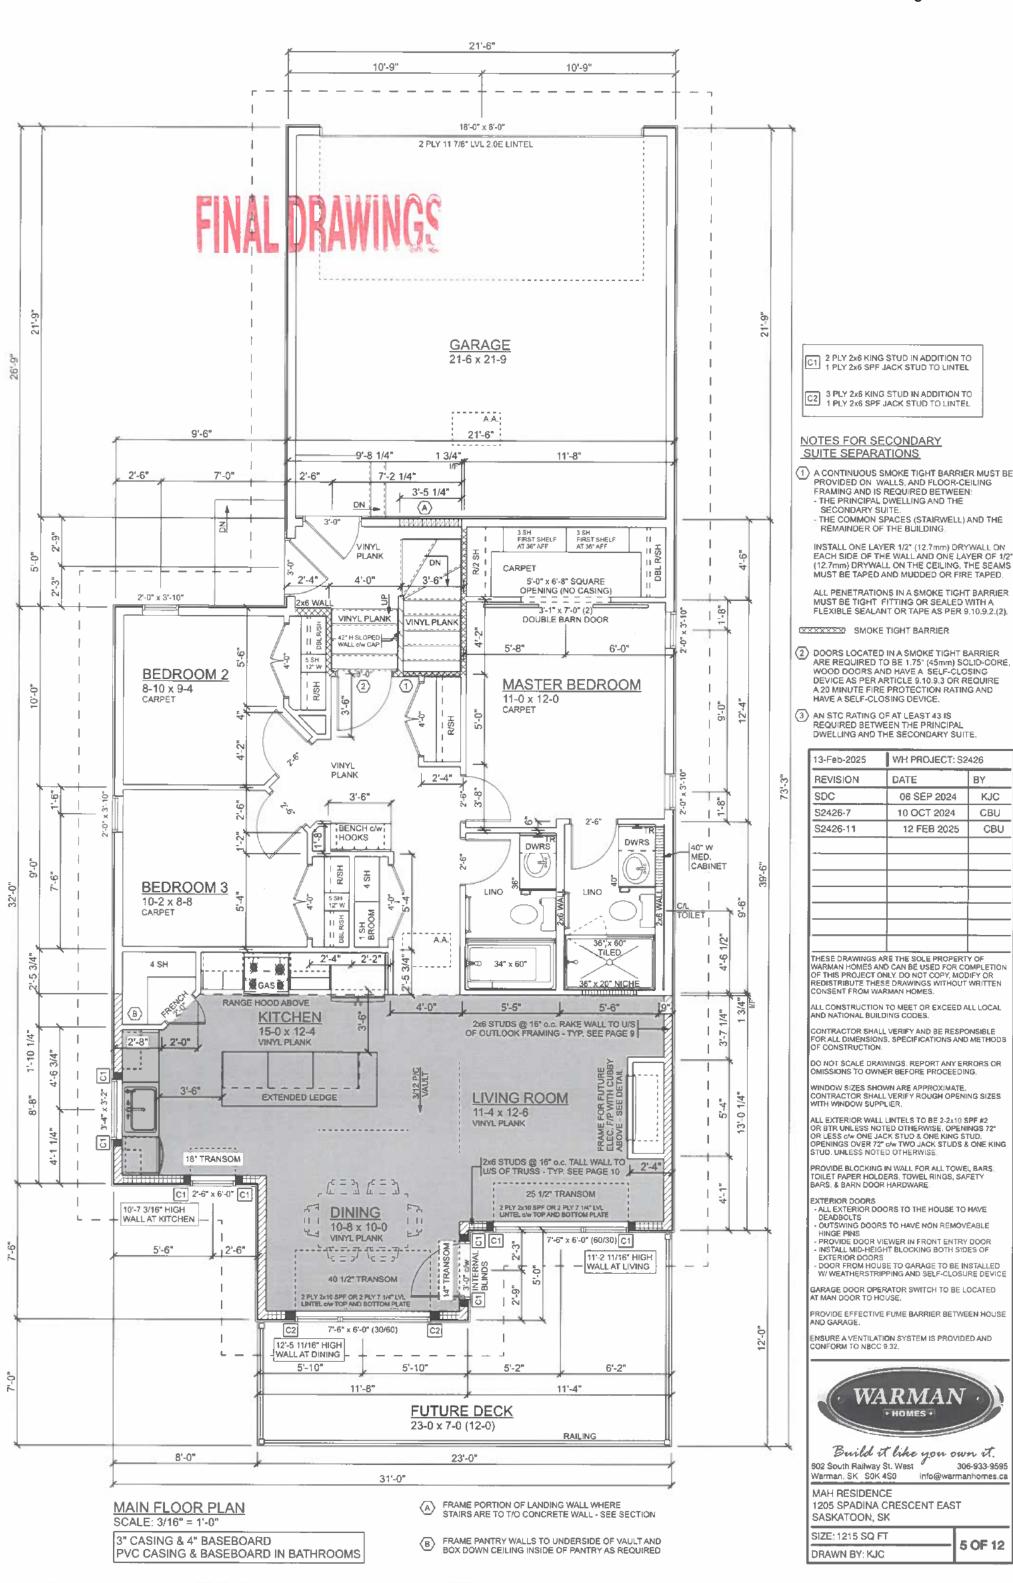
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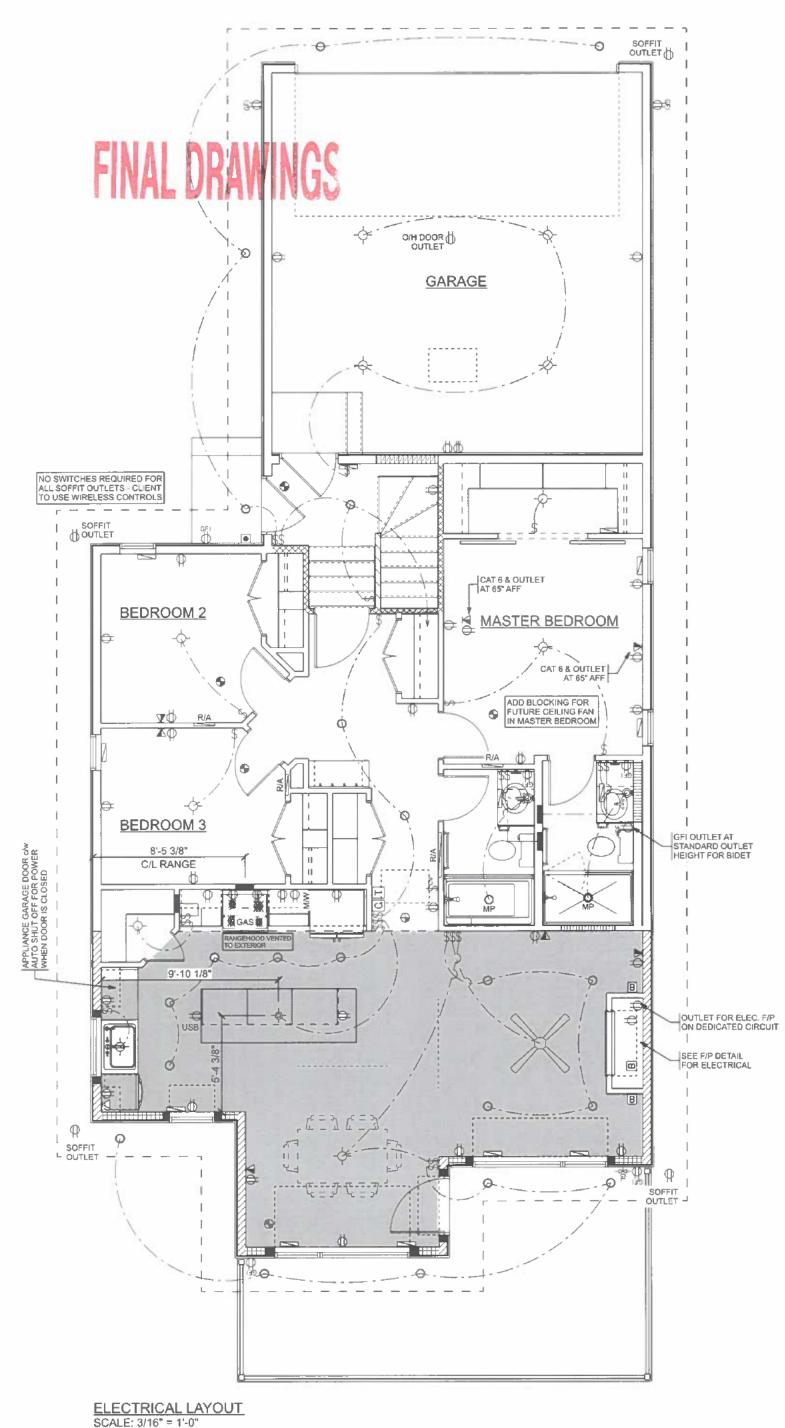


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MAH RESIDENCE 1205 SPADINA CRESCENT EAST SASKATOON, SK

SIZE: 1215 SQ FT DRAWN BY: KJC





ELECTRICAL LEGEND	
ELECTRICAL	SYMBOL
14 Inch Return Air	
30 Inch Return Air	
Cat 5 Telephone	$\nabla$
Central Vent Switch	\$°
Coax & Cal 6 Ethernet	A
Doorbell	•
Door Chime	C
Gas Line	r‡GL
Heat Register	
Light	- <b>\(\rightarrow\)-</b>
Outlet	d)
Outlet 220v	ä
Outlet GFI	#
Pendant Light	-ф-
Pot Light	0
Smoke & CO Detector	9
Smoke Detector	•
Switch	\$
Thermostat	T
Vent Duct	
Wall Mount Light	0

18-Feb-2025	WH PROJECT: \$2426	
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ELECTRICAL WIRES NOT PERMITTED TO RUN PERPENDICULAR TO TRUSSES IN ANY AREAS GREATER THAN 3°-3 3/8" IN HEIGHT

MECHANICAL AND ELECTRICAL LOCATIONS MAY BE ADJUSTED BY CONTRACTOR AS REQUIRED.



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6 OF 12

1205 SPADINA CRESCENT EAST SASKATOON, SK

SIZE: 1215 SQ FT

DRAWN BY: KJC

MAH RESIDENCE

IF OWNER REQUIRES POTLIGHTS IN AN EXACT LOCATION, IT SHOULD BE NOTED ON PLAN AND ADDITIONAL CHARGES WILL APPLY.

ADJUSTED TO SUIT ROOF TRUSS LOCATIONS.


ALL POTLIGHT LOCATIONS ARE AN ESTIMATE ONLY AND MAY NEED TO BE


EXCEPT WALK-IN CLOSET AND PANTRY LIGHT CAT 6 OUTLETS THROUGHOUT

PVC CASING & BASEBOARD IN BATHROOMS

DIMMER SWITCH ON EACH LIGHT THROUGHOUT

3" CASING & 4" BASEBOARD

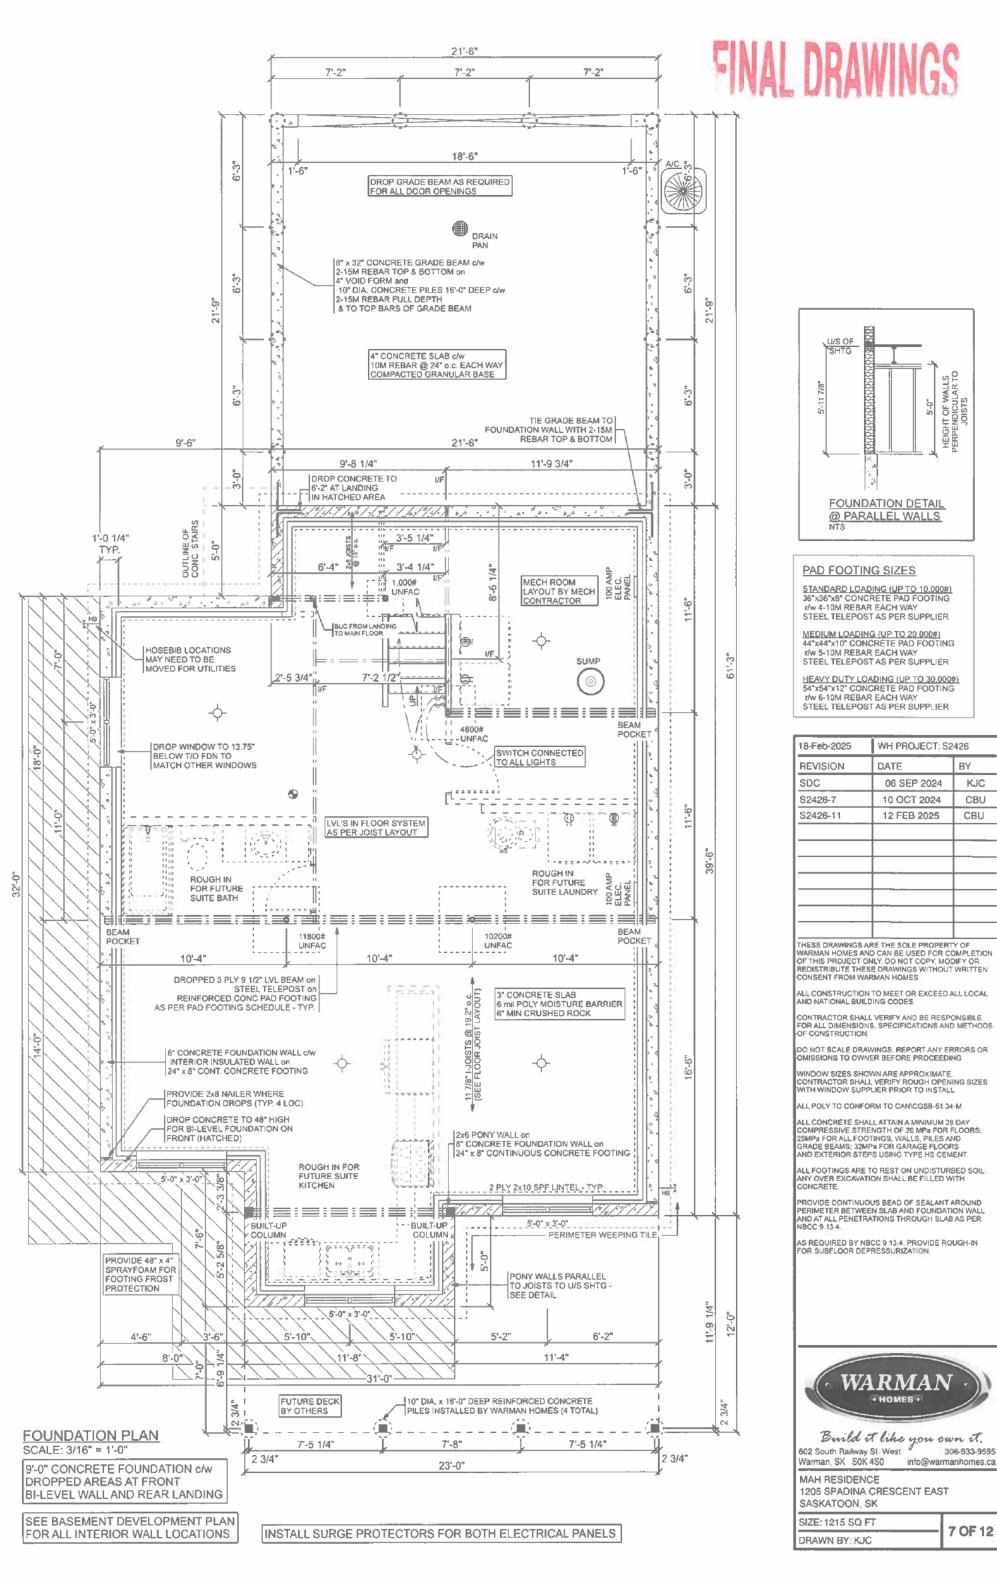

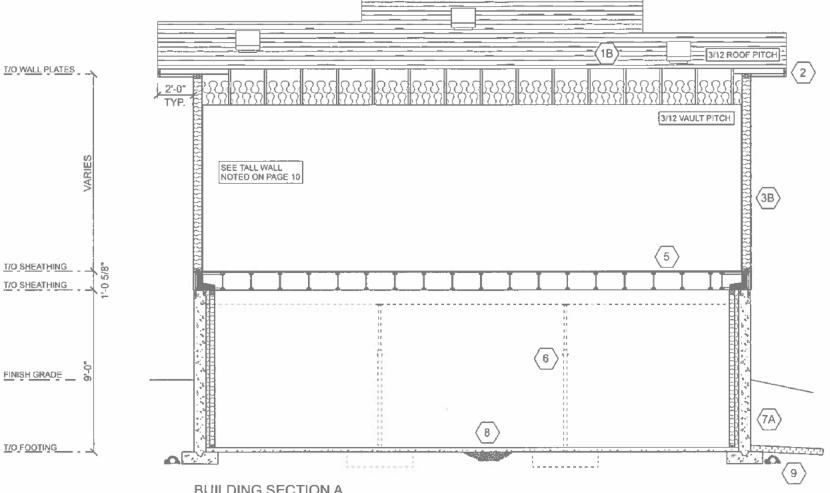

# FINAL DRAWINGS

SOUND TRANSMISSION REQUIREMENTS AS PER ARTICLE 9.11.1.1(2). - NOT SHOWN IN SECTION (FUTURE SUITE)

#### INTERIOR WALL (43 STC)

A) 1/2" DRYWALL 2x4 or 2x6 STUDS @ 16" o.c. SOUND ABSORBING MATERIAL RESILIENT METAL CHANNEL @ 16" o.c. OR 24" o.c. 1/2" DRYWALL

### FLOOR ASSEMBLY (43 STC)

FINISHED FLOOR
3/4" T&G OSB (AND ULAY AS REQUIRED)
ENGINEERED JOISTS @ MAX 24" o.c.
MINIMUM 150mm SOUND ABSORBING MATERIAL
RESILIENT METAL CHANNELS @ 16" o.c. OR 24" o.c.
1/2" CD DRYWALL

BUILDING SECTION A SCALE: 3/16" = 1'-0"

ROOF SYSTEM

SHINGLES
ROLL ROOFING EAVE PROTECTION
(MIN. 48" UP ROOF)
7/16" ROOF SHEATHING CW H-CLIPS
PRE-ENGINEERED TRUSSES @ 24" o.c.
TRUSS BRACING AS PER MANUFACTURERS
RECOMMENDATIONS
R50 (RSI 8.8) BLOWN-IN INSULATION
CARDBOARD INSULATION STOPS @ EAVES
6 mil POLY V.B.
1/2" CD DRYWALL

1B VAULTED ROOF SYSTEM

SHINGLES
ROLL ROOFING EAVE PROTECTION
(MIN. 48" UP ROOF)
7/16" ROOF SHEATHING OW H-CLIPS
PRE-ENGINEERED TRUSSES @ 24" o.c.
TRUSS BRACING AS PER MANUFACTURERS
RECOMMENDATIONS
TWO LAYERS R28 (RSI 4.935) BATT INSULATION
CARDBOARD INSULATION STOPS @ EAVES
6 mil POLY V.B.
1/2" CD DRYWALL

2 EAVES

2x6 FASCIA BOARD PRE-FINISHED METAL SOFFIT, FASCIA & EAVESTROUGHING

MALL EXTERIOR WALL

EXTERIOR FINISH AS PER ELEVATIONS BUILDING PAPER or HOUSEWRAP 7/16" WALL SHEATHING 2x6 STUDS @ 24" o.c. U.N.O. R24 (RSI 4.23) BATT INSULATION 6 mit POLY V.B. 1/2" DRYWALL (DRYWALL INTERIOR OF MAIN FLOOR WALLS ONLY)

3B EXTERIOR WALL (TALL WALL)

EXTERIOR FINISH AS PER ELEVATIONS BUILDING PAPER of HOUSEWRAP 7/16" WALL SHEATHING 2x6 STUDS @ 16" o.c. OR AS NOTED BY P.ENG ON PLAN R24 (RSI 4.23) BATT INSULATION 6 mil POLY V.B. 1/2" DRYWALL

INTERIOR WALL

1/2" DRYWALL 2x4 STUDS U.N.O. @ 16" o.c. 1/2" DRYWALL

FLOOR SYSTEM

FINISHED FLOORING 3/8" ULAY IN LINO AREAS 3/4" T & G OSB FLOOR SHEATHING 11 7/8" I-JOISTS @ 19.2" o.c.

BEAM/POST/FOOTING

BEAM AS PER PLAN on STEEL TELEPOST on REINFORCED CONC PAD FOOTING AS PER PAD FOOTING SCHEDULE

FOUNDATION WALL (9' CONC.)

DAMPPROOF BOTH SIDES BELOW GRADE AND PARGING ABOVE GRADE 8" CONCRETE FOUNDATION WALL c/w 2-10M REBAR HORIZONTAL T/M/B and 15M VERTICAL REBAR @ 24" o.c. on 24" x 8" CONTINUOUS CONCRETE FOOTING c/w 2-10M REBAR c/w 2x4 STUDS @ 24" o.c. R24 (RSI 4.23) BATT INSULATION 6 mil POLY V.B.

FOUNDATION WALL (BI-LEVEL)

DAMPPROOF BOTH SIDES BELOW GRADE
AND PARGING ABOVE GRADE
8\* CONCRETE FOUNDATION WALL c/w
2-10M REBAR HORIZONTAL T/B and
15M VERTICAL REBAR @ 24\* 0.c.on
24\* x 8\* CONTINUOUS CONCRETE FOOTING c/w
2\*4 STUDS @ 24\* 0.c.
R24 (RSI 4.23) BATT INSULATION
6 mil POLY V.B.

SLAB FLOOR

3" CONCRETE SLAB 6 mil POLY MOISTURE BARRIER 6" MIN. CRUSHED ROCK

WEEPING TILE

4" DIA. SOCKED WEEPING TILE IN 6" CRUSHED STONE (CLEAR) CONNECTED TO SUMP PUMP (SLOPE EXCAVATION TO SUMP)

RIM JOIST INSULATION

3" MED. DENSITY SPRAYFOAM INSULATION L/W FIREGUARD IN ALL PERIMETER JOIST SPACES. CONTRACTOR TO ENSURE CONTINUITY OF INSULATION & AVB REQUIREMENTS ARE MET

11 HOUSE / GARAGE WALL

7/16\* WALL SHEATHING 2x6 STUDS @ 24\* o.c. U.N.O. R24 (RSI 4.23) BATT INSULATION 6 mil POLY V.B. 1/2\* ORYWALL GARAGE ROOF

SHINGLES C/W
ROLL ROOFING EAVE PROTECTION
(MIN. 48" UP ROOF)
7/16" ROOF SHEATHING C/W H-CLIPS
PRE-ENGINEERED TRUSSES @ 24" o.c.
TRUSS BRACING AS PER MANUFACTURERS
RECOMMENDATIONS
CARDBOARD INSULATION STOPS AT EAVES

GARAGE WALL

EXTERIOR FINISH AS PER ELEVATIONS BUILDING PAPER OF HOUSEWRAP 7/16" WALL SHEATHING 2x6 STUDS @ 24" o.c.

GRADE BEAM & PILE

8" x 32" CONCRETE GRADE BEAM c/w
2-15M REBAR TOP & BOTTOM on
4" VOID FORM and
10" DIA. CONCRETE PILES 16'-0" DEEP c/w
2-15M REBAR FULL DEPTH
& TO TOP BARS OF GRADE BEAM

15 GARAGE SLAB FLOOR

4" CONCRETE SLAB r/w 10M REBAR @ 24" o.c. EACH WAY COMPACTED GRANULAR BASE

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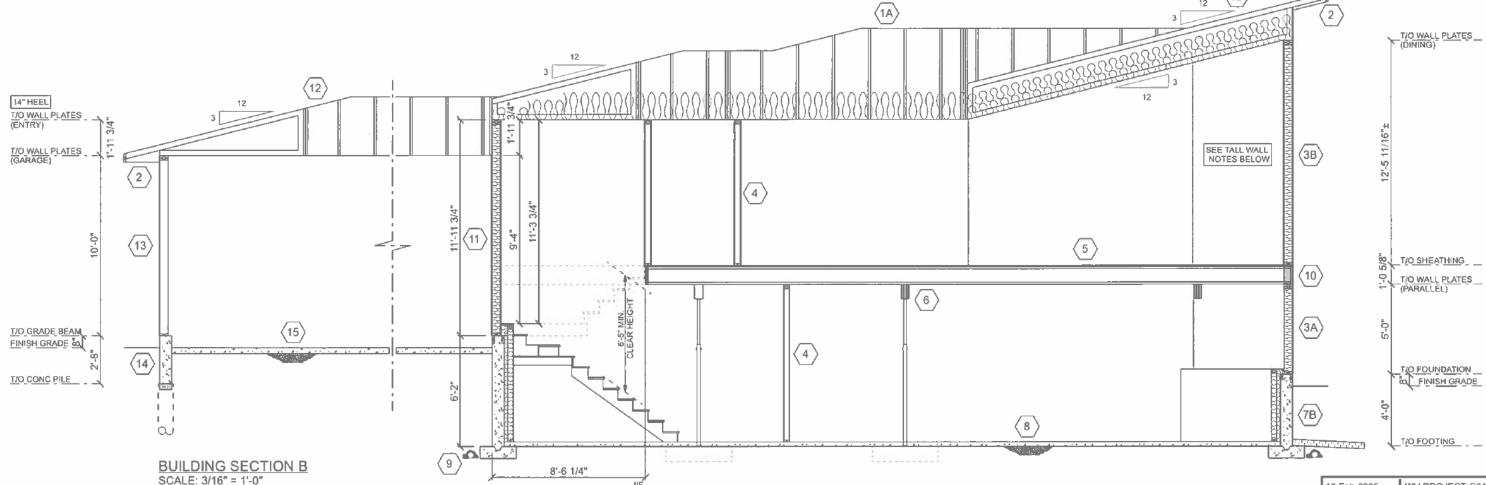
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MAH RESIDENCE 1205 SPADINA CRESCENT EAST SASKATOON, SK

SIZE: 1215 SQ FT DRAWN BY: KJC



- ROOF SYSTEM
- VAULTED ROOF SYSTEM
- **EAVES**
- **EXTERIOR WALL**
- EXTERIOR WALL (TALL WALL)
- **INTERIOR WALL**
- FLOOR SYSTEM
- **BEAM/POST/FOOTING**
- FOUNDATION WALL (9' CONC.)
- FOUNDATION WALL (BI-LEVEL)

- SLAB FLOOR
- **WEEPING TILE**
- **RIM JOIST INSULATION**
- **HOUSE / GARAGE WALL**
- GARAGE ROOF
- **GARAGE WALL**
- **GRADE BEAM & PILE**
- **GARAGE SLAB FLOOR**

### ENGINEERED TALL WALL FRAMING NOTES

- Install all lintels, jack studs, cripples, plates, sheathing and fasteners as per current NBCC.
   Install min, 3/8\* OSB or plywood sheathing on exterior.

- Top and bottom plates to be SPF material.
   Tall wall studs & king studs to be full height continuous to underside of top plates supporting truss heel or outlook framing. Jack studs to run full height, continuous to uppermost lintef.
- Install Simpson L50 top & bottom of built-up columns (king studs plus jack studs). Install clip on both sides of column where possible. 6. Fasten built-up columns w/ (2) nails @ 8" o.c. each ply (4" from top and bottom of wall). Install
- nails both sides for jack stud.
  7. Full depth SPF blocking at max. 4' o.c.
- Install Simpson L50 to one side of each truss heel (or outbook framing) that bear on tall wall.
   Install all Simpson framing clips with manufacturer approved fasteners.
   Install (3) end nails in each stud & lintel plate. Lintels to have SPF top & bottom plate.
- Lintels to be minimum 2pty 2x10 u.n.o.

  11. Install full depth crush blocking below built-up columns (king studs/jack studs) in joist space.
- 12. Nails to be 3-1/4" U.N.O.
- 13. Wood Properties: S-P-F No.2 or better
- 14. Engineered Wood Properties: LVL 2.0E or better
- 15. Tall wall is not engineered as a shear wall. Overall lateral stability designed by others.
- Tall wall is defined as a serior wood wall with an unsupported height greater than 12'-0".

   Refer to door/window manufacturer's specifications for recommended rough opening dimensions.

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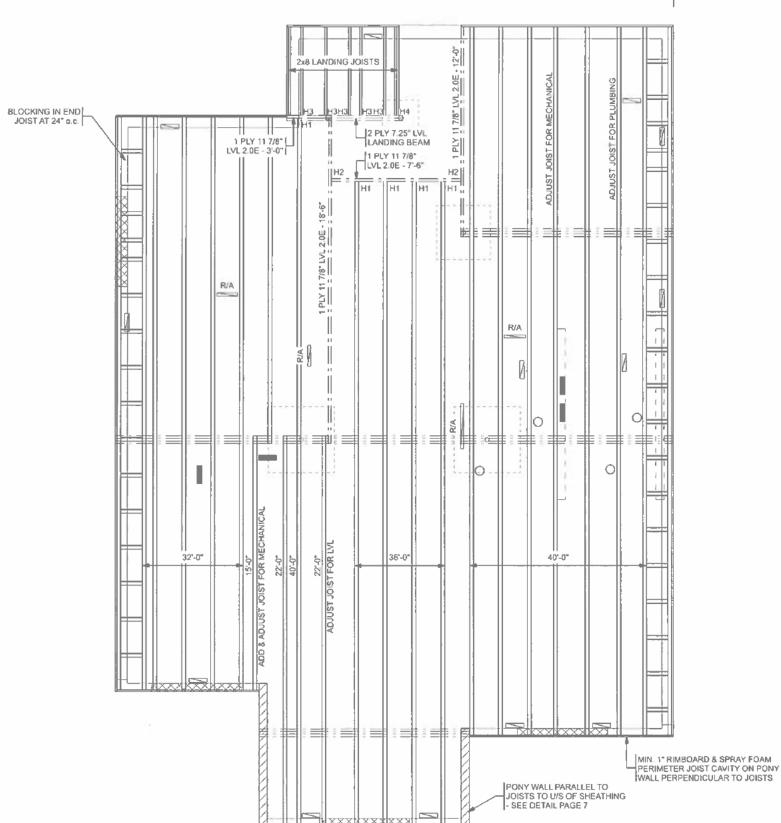
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MAH RESIDENCE 1205 SPADINA CRESCENT EAST SASKATOON, SK

SIZE: 1215 SQ FT DRAWN BY: KJC







**FLOOR JOIST LAYOUT** SCALE: 3/16" = 1'-0"

# FINAL DRAWINGS

# Appeal 12-2025

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REFER TO PLANS FOR ALL DIMENSIONS.

THIS LAYOUT IS A GUIDE ONLY CONFIRMATION OF ALL QUANTITIES, LENGTHS AND DETAILS REMAIN THE RESPONSIBILITY OF THE INSTALLING CONTRACTOR

IT IS THE FRAMERS RESPONSIBILITY TO ENSURE THAT THE JOISTS DO NOT CONFLICT WITH PLUMBING STACKS AND OTHER OPENINGS THROUGH THE FLOOR. ADJUST JOISTS MAXIMUM 2" IF REQUIRED OR ADDITIONAL JOISTS MAY BE REQUIRED.

ALL FLOOR SHEATHING TO BE GLUED AND SCREWED TO FLOOR JOISTS AND BEAMS.

POINT LOADS FROM ABOVE SHALL BE SOLID BLOCKED TO BEARING BELOW.

MINIMUM END BEARING FOR JOISTS SHALL BE 1,75° AND INTERMEDIATE BEARING SHALL BE 3.5° UNO

REFER TO PK INSTALLATION GUIDE FOR ALL CONSTRUCTION DETAILS.

### FRAMING MEMBERS

FLOOR JOISTS = 11.875" PKI20 I-JOIST FLOOR GIRDERS = 11.875" LVL 2.0E

\* LENGTH AND SPACING AS NOTED ON LAYOUT\*

# HANGER LIST H1 LF2511 H2 HUS1.81/10 H3 LUS28 H4 LUS28-2

### **DESIGN ASSUMPTIONS**

SHEATHING MATERIAL CEILING MATERIAL CEILING STRAPS BRIDGING MATERIAL NUMBER OF ROWS

INCLUDES COMO VIBRATION CHECK

LIVE LOAD DEAD LOAD TOTAL LOAD

LIVE LOAD DEFLECTION TOTAL DEFLECTION



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MAH RESIDENCE 1205 SPADINA CRESCENT EAST SASKATOON, SK

SIZE: 1215 SQ FT

DRAWN BY: KJC


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3/4" OSB


NONE

40 PSF 15 PSF 55 PSF


L/480 L/240

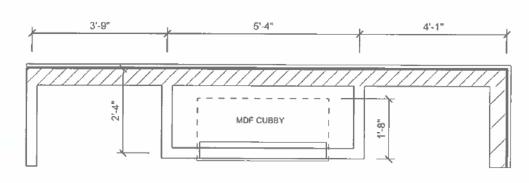


## FIREPLACE PLAN

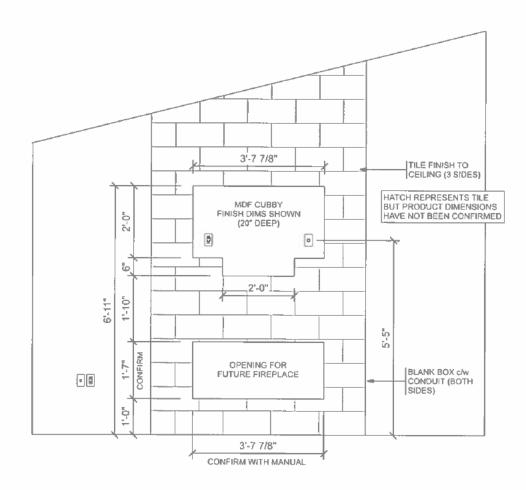


**FIREPLACE ELEVATION** 

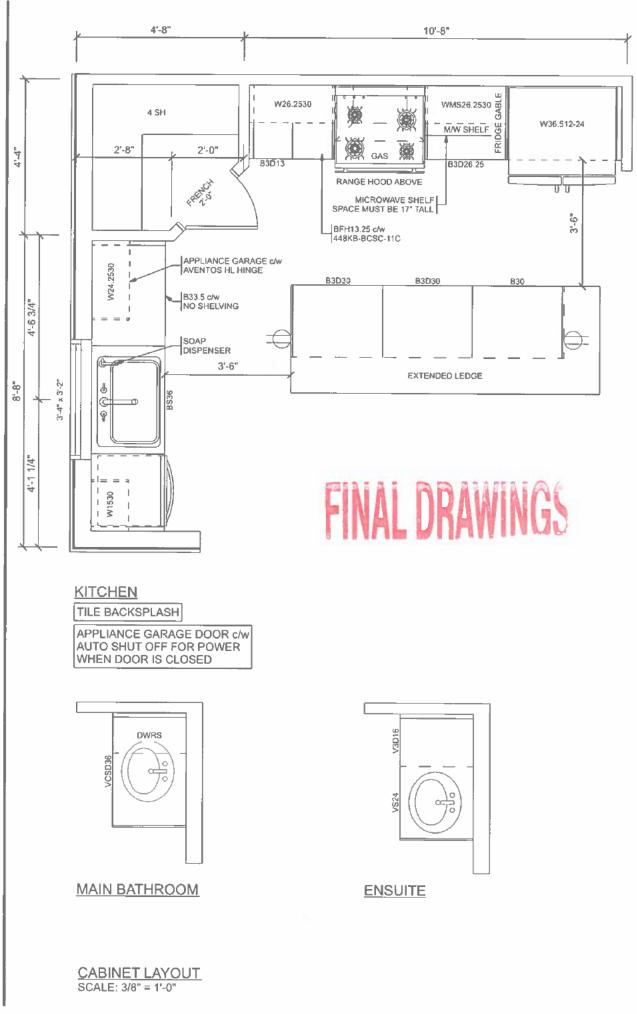

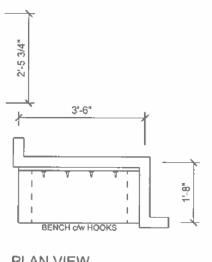

## **PLAN VIEW**

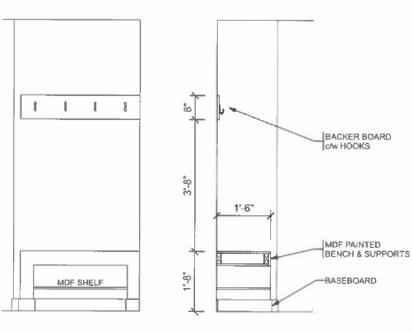

### **ELEVATION VIEW**

MDF BENCH SECTION - 3.5" (2x4) FRAMED BENCH COVERED IN 5/8" MDF - 8" BACKER BOARD c/w HOOKS - NO SHELF

**BENCH DETAIL** SCALE: 3/8" = 1'-0"

- OPEN BELOW (MAX \$PAN 5' WITHOUT SUPPORT)

REFER TO PRODUCTION SCHEDULE FOR FINISH DOOR STYLE, MOULDINGS AND ALL ACCESSORIES.

SOFTCLOSE DOORS & DRAWERS THROUGHOUT.

WARMAN

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MAH RESIDENCE 1205 SPADINA CRESCENT EAST SASKATOON, SK

WH PROJECT: S2426 REVISION: S2426-6 13-Feb-2025 SIZE: 1215 SQ FT

12 OF 12 DRAWN BY: KJC